

SITE AERIAL SCALE: N.T.S.

DEVELOPMENT PLAN & CONDITIONAL USE PERMIT

PROJECT NAME: Project #732035 - abutting U-Haul Moving & Storage of Murrieta

Applicant: Jason Mastrana, Owner's Representative
P. (949) 375-5976 Email: jason_mastrana@uhaul.com

Land Owner: Amerco Real Estate Company
2727 North Central Avenue, Phoenix, AZ 85004, (602) 263-6502

Exhibit Preparer: A. Owner
B. Inland Empire Survey & Engineering, Inc. c/o Alex Paulsen
41146 Elm St. Murrieta, CA 92562, (951) 698-1830
C. B.M.A. c/o Steve Shirel
310 N. Joy St., Corona, CA 92689, (760) 737-1124

MUNICIPALITY: City of Murrieta

PARCEL SIZE: Parcel 3 - APN - 949-220-013-6 - 20.895 s.f. / 0.48 acres
Parcel 4 - APN - 949-220-014-7 - 27.233 s.f. / 0.63 acres
Total Gross Area/Acreage - 48.128 s.f. / 1.11 acres
Total Net Area/Acreage - 48.128 s.f. / 1.11 acres
Overall Dimensions - 199.00' X 241.75'

ZONE: CC - Community Commercial
Overlay: TOD Overlay

ADJACENT ZONING: N. CC - Community Commercial
E. CC - Community Commercial
S. MF-3 - Residential
W. MF-3 / CC - Residential / Community Commercial

EXISTING USES: Vacant Land

PERMITTED USES: Retail
Self-Storage facilities - CUP
Automobile & Truck Rental - CUP

PROPOSED USE: Self-Storage

LOT COVERAGE: Proposed Building - 15,579 s.f.
Total Lot Coverage - 15,579 s.f. = 32%

PROPOSED BUILDING: BUILDING TYPE: IIB, USE GROUP: S1, FLOORS: 1, Fully Sprinklered, HEIGHT: Varies (50'-0", and 42'-0")

PROJECT TITLE LEGAL DESCRIPTION:
PARCEL 3, AS SHOWN BY PARCEL MAP 7654, IN THE CITY OF MURRIETA, COUNTY OF RIVERSIDE, STATE OF CALIFORNIA, ON FILE IN BOOK 25, PAGE 82 OF PARCEL MAPS, RECORDS OF RIVERSIDE COUNTY, CALIFORNIA. APN: 949-220-013-6
PARCEL 4, AS SHOWN BY PARCEL MAP NO. 7654, IN THE CITY OF MURRIETA, COUNTY OF RIVERSIDE, STATE OF CALIFORNIA, ON FILE IN BOOK 23 PAGE 86 OF PARCEL MAPS, RECORDS OF RIVERSIDE COUNTY, CALIFORNIA. APN: 949-220-014-7

*PARCELS 3 & 4 TO BE MERGED

SHEET NOTES:

NO.	DATE	INITIALS	NOTES
9	03/06/24	BIC	SHIFT BLDG. L/S REVS. MOVE TRASH ENCL.
10	04/08/24	NH	REV'S PER CITY COMMENTS
11	07/12/24	NH	REV'S PER CITY COMMENTS

REVISIONS:

NO.	DATE	INITIALS	NOTES
1	11/12/21	JS	REV'D LANDSCAPE/SP2 PER CITY COMMENTS
2	02/17/22	JS	REV'D BUILDING "C" FLOOR PLAN
3	04/28/22	JS	REV'D SITE PLAN PER CITY COMMENTS
4	11/02/23	JS	REV'D FLOOR PLAN/LAYOUT
5	02/14/23	JS	REV SITE PLAN PER COMMENTS
6	08/30/23	JS	REV PER CITY COMM./ ADDED L/S AREA
7	10/20/23	NH	SITE REV'S
8	11/09/23	JS	REV TO INC. PATH OF TRAVEL/ CITY COMM.

PROFESSIONAL SEAL:
**PRELIMINARY DOCUMENTS,
NOT FOR CONSTRUCTION,
FOR INFORMATION ONLY.**

ARCHITECT LOGO:

AMERCO REAL ESTATE COMPANY
CONSTRUCTION DEPARTMENT
2727 NORTH CENTRAL AVENUE
PHOENIX, ARIZONA 85004
P: (602) 263-6502

SITE ADDRESS:
U-Haul of Murrieta
Murrieta, CA

SHEET CONTENTS:
Proposed
Site Plan

732035

DRAWN: JS
CHECKED: NH
DATE: 02/16/2023

Development Services Department
Planning Division
Received on: 08/09/2024
Case #

COMMERCIAL ZONES
GENERAL DEVELOPMENT STANDARDS REQUIREMENTS


Development Feature	Required	Proposed
Minimum Site Area	None	None
Setbacks		
Street	25-ft.	25-ft.
Interior (adjacent to commercially zoned properties)	0 or 10-ft.	20-ft. Abutting East Prop. Line 10-ft. Abutting both North & South Prop. Line
Interior (adjacent to residential zoned properties)	20-ft. minimum or equal to building height, whichever is greater	N/A
Interior (adjacent to a freeway)	25-ft. minimum	N/A
Maximum Building Height	50-ft.	50-ft.
Minimum On-Site Landscaping	20 percent (Req. 9,625-SF.)	20 percent (Provided 9,820-SF.) (APN 949-220-013-6 & APN 949-220-014-7)
Lot Coverage	Approx. 80 percent	Approx. 80 percent

NONRESIDENTIAL STRUCTURES MINIMUM STORAGE AREAS REQUIRED

Building Floor Area (sq.ft.)	Refuse	Recycling	Total Area Required	Total Area Proposed
10001-25,000 SF	48 SF	48 SF	96 SF	128 SF

SELF-STORAGE PARKING REQUIREMENTS


Required	Provided
4 Spaces for the manager's office, plus 1 additional space if an on-site residential unit is provided.	6 spaces in total
ADA	1 space
Clean Air/Van Pool/EV Vehicle	0 spaces
EVCS Vehicle	0 spaces
Bicycle Parking	2 bicycles

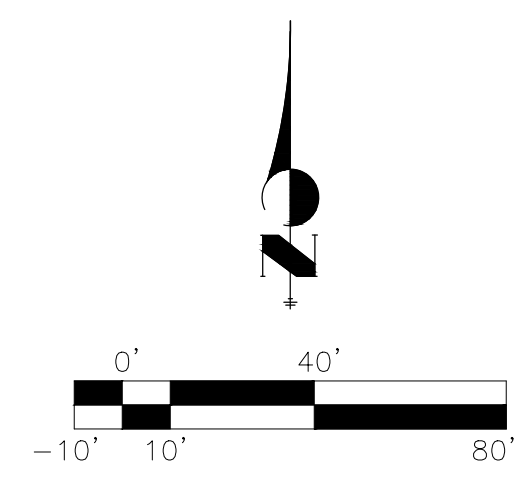


PROPOSED SITE PLAN

SCALE: 1" = 40' - 0"



SITE DATA

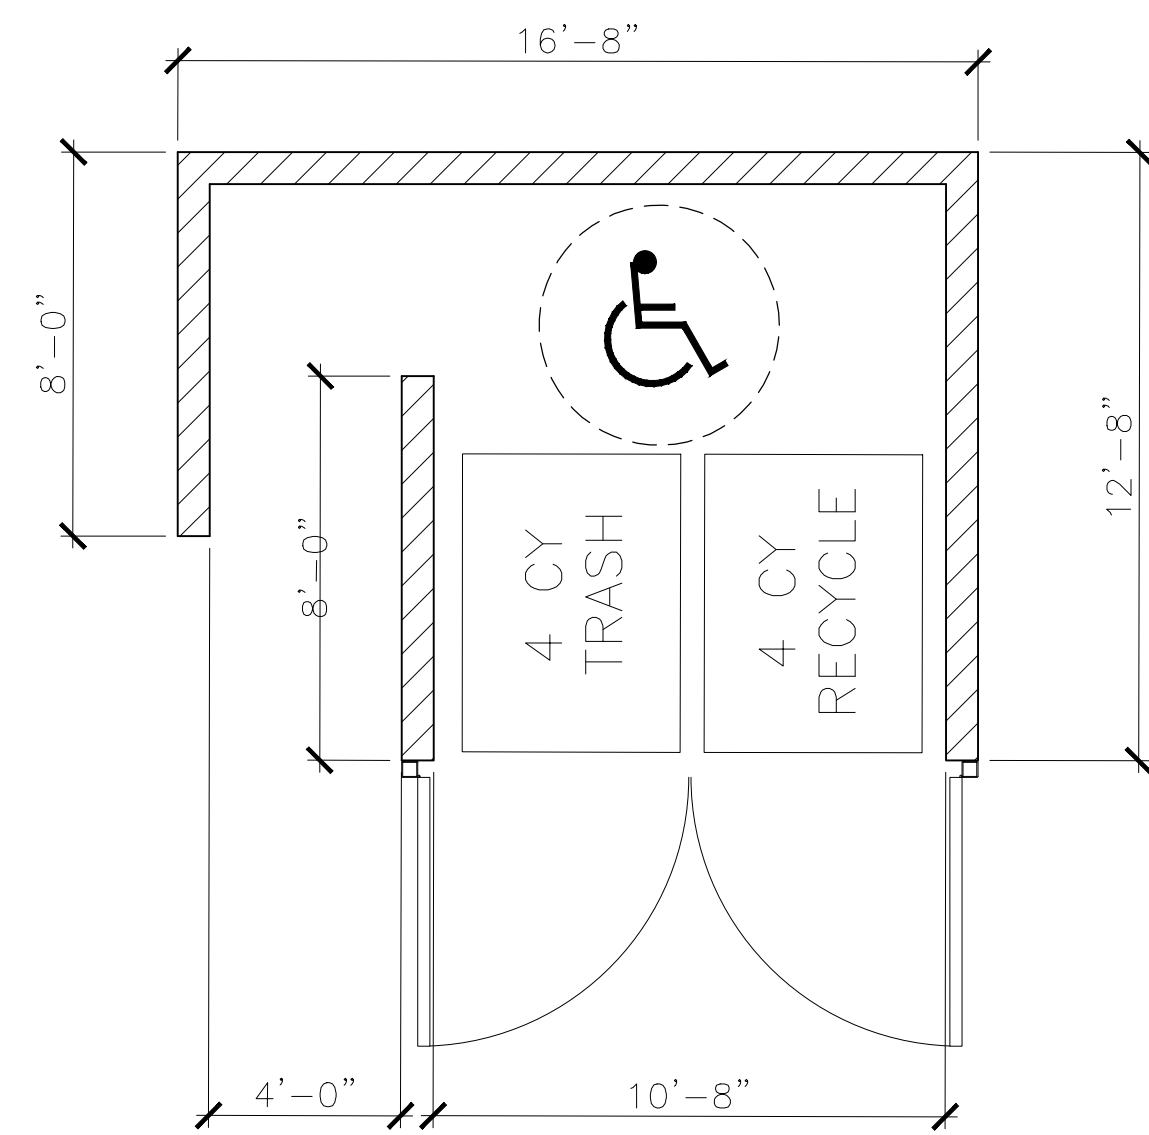

NOTE:
 1. 8" X 16" SPLIT FACE BLOCK PAINTED TO MATCH BUILDING
 2. WOOD TRELLIS MOUNTED OVER-HEAD
 SEE DETAIL 2/SP3

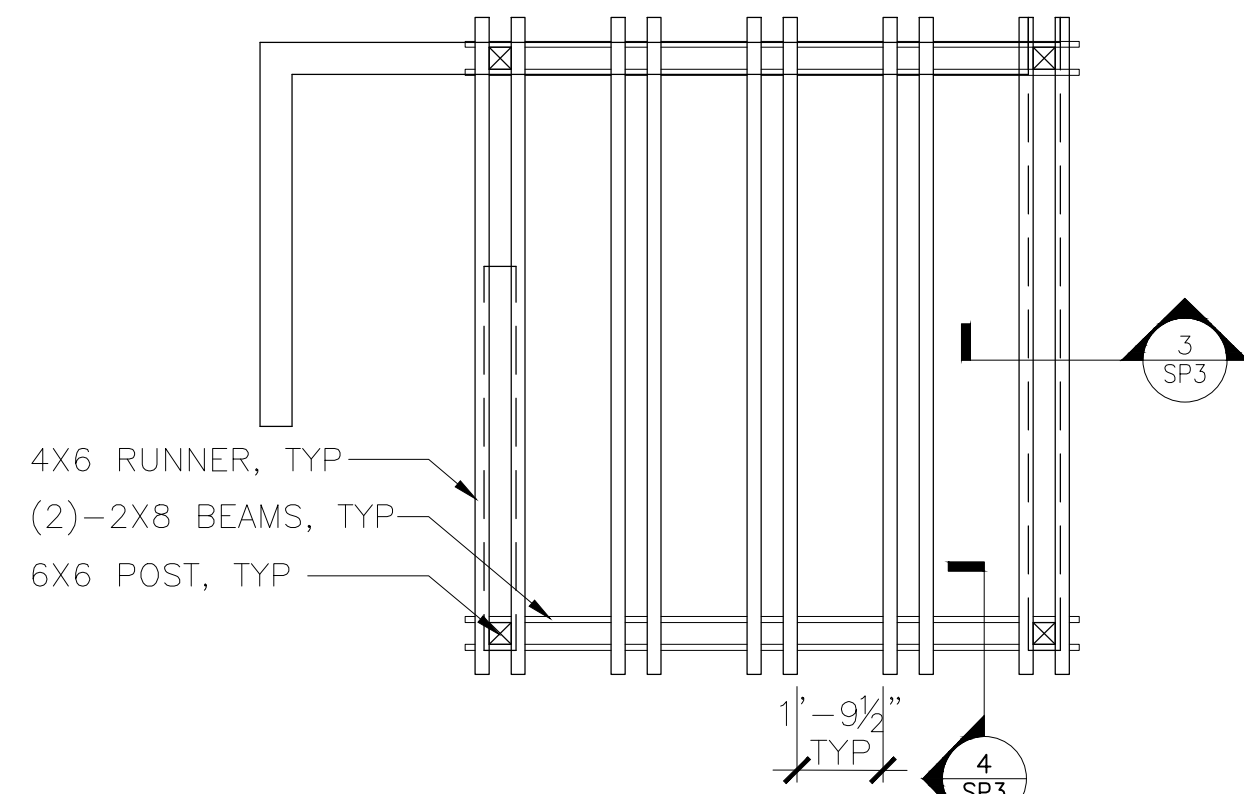

NOTE:
 1. ALL HARDWARE SHALL BE GALVANIZED
 2. ALL TIMBER AND LUMBER SHALL BE PRESSURE TREATED SPRUCE PINE FUR, STUD-GRADE (OR EQUAL)

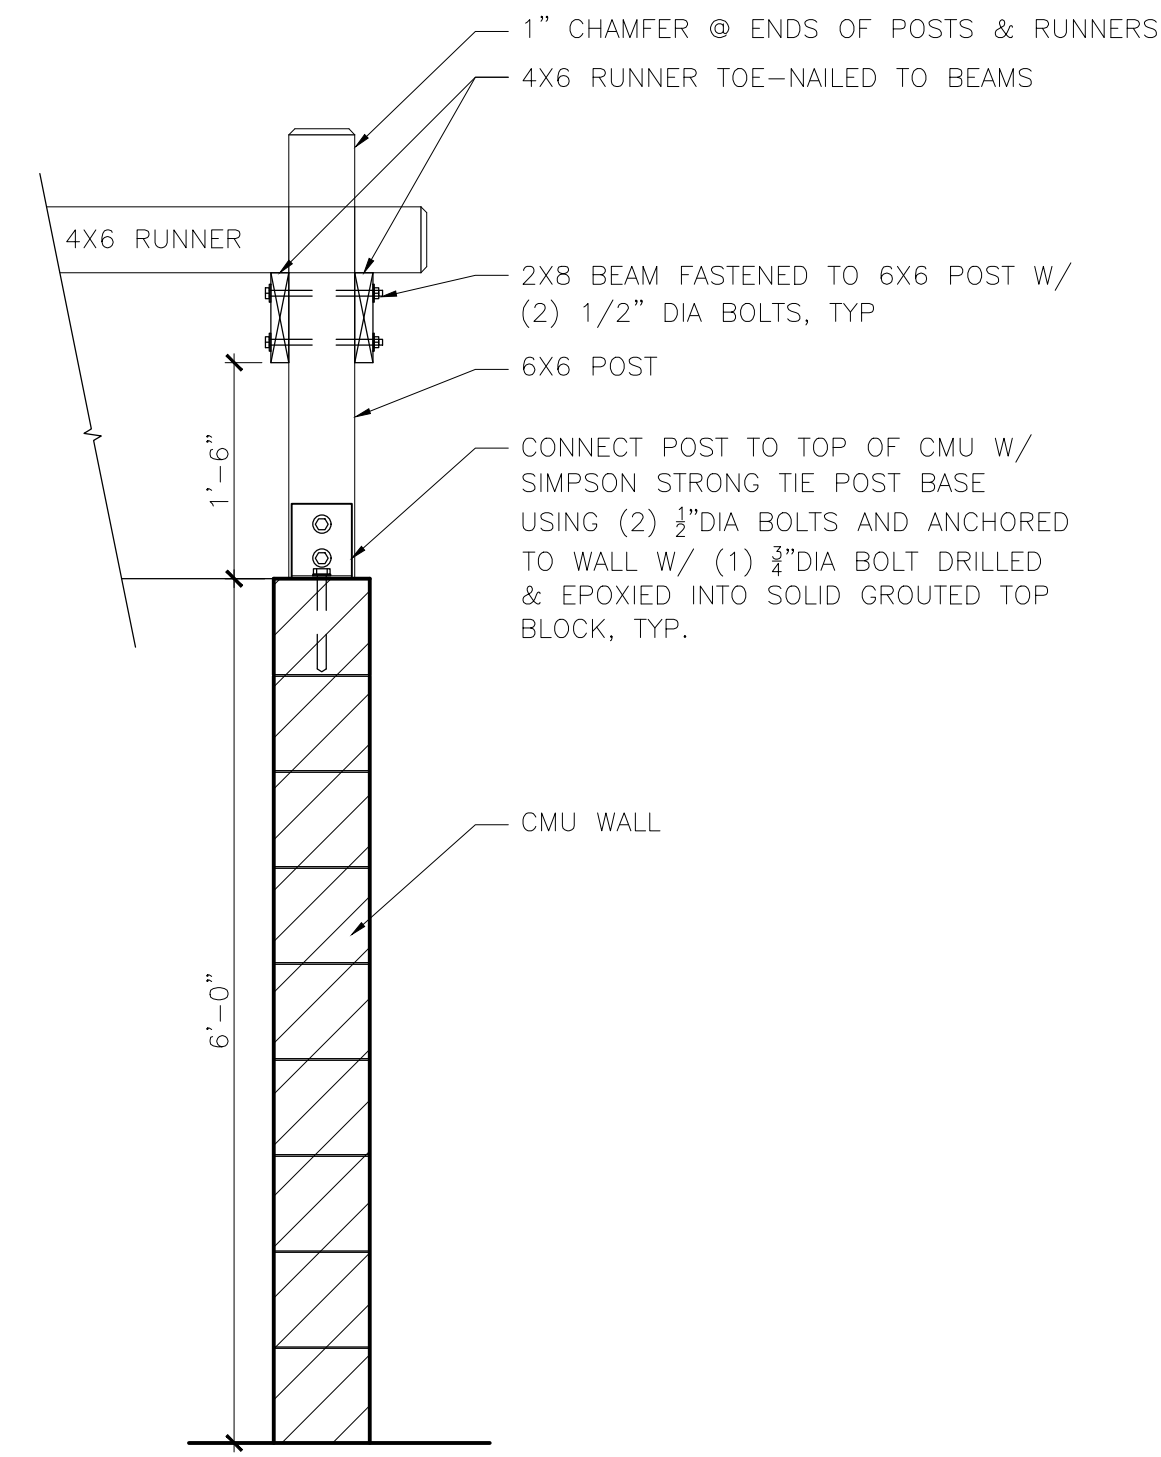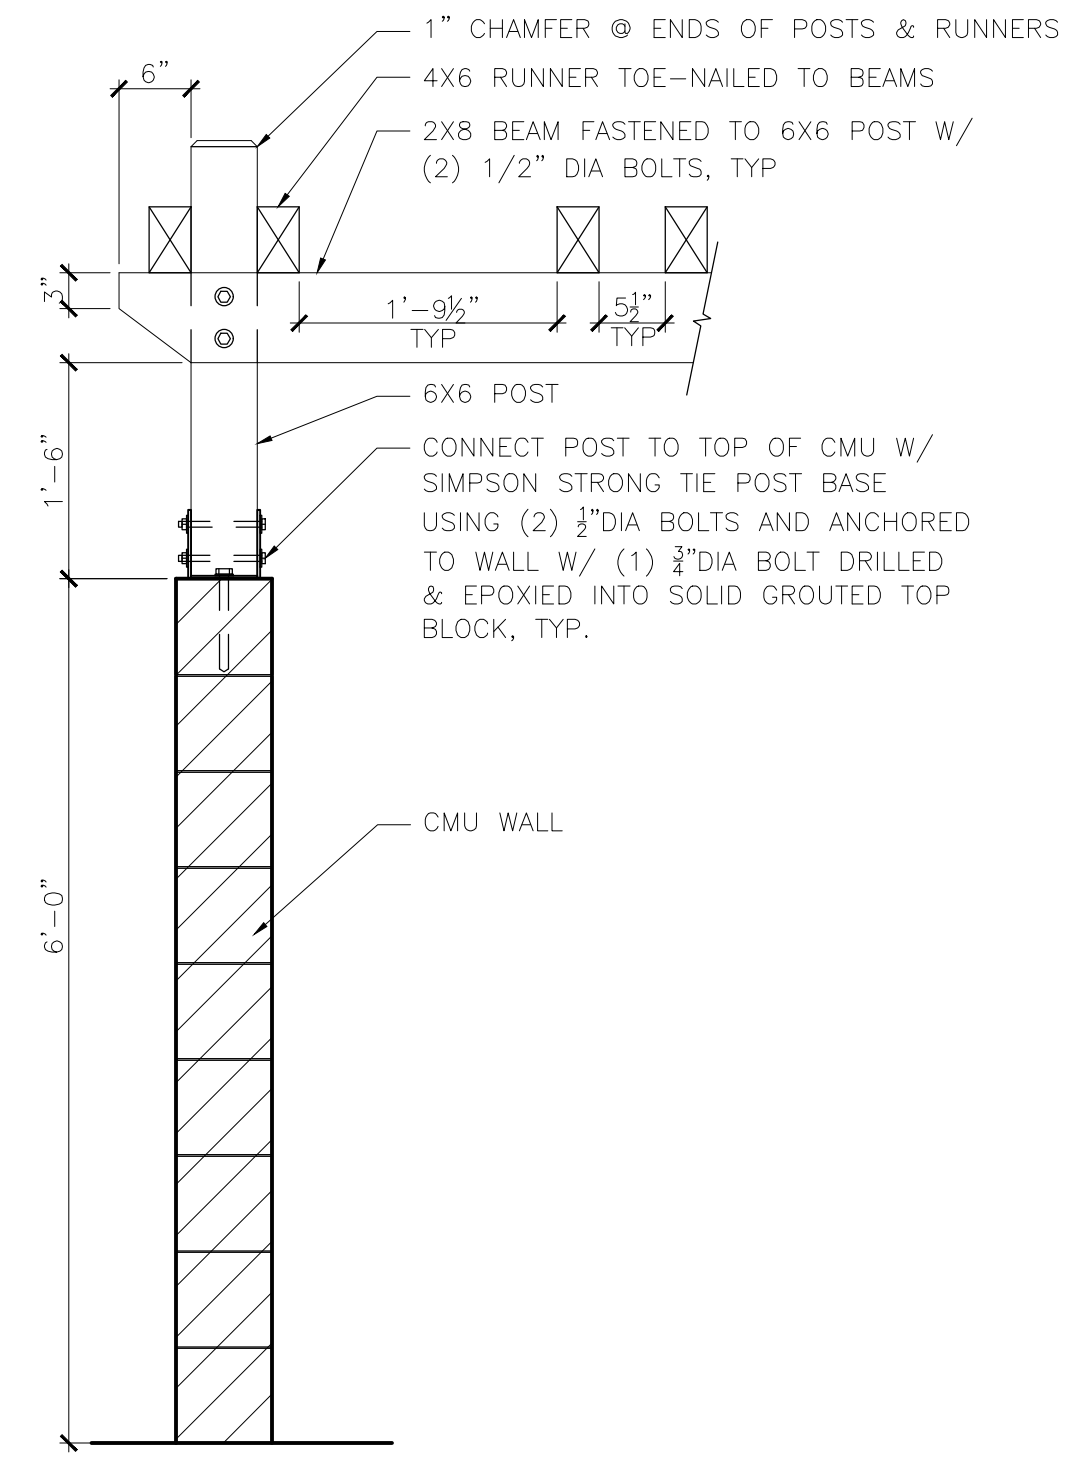


1 PROPOSED CMU TRASH/REC. SCALE: 1/4" = 1'-0"




2 OVERHEAD WOOD TRELLIS SCALE: 1/4" = 1'-0"

3 OVERHEAD WOOD TRELLIS SCALE: 3/4" = 1'-0"

4 OVERHEAD WOOD TRELLIS SCALE: 3/4" = 1'-0"

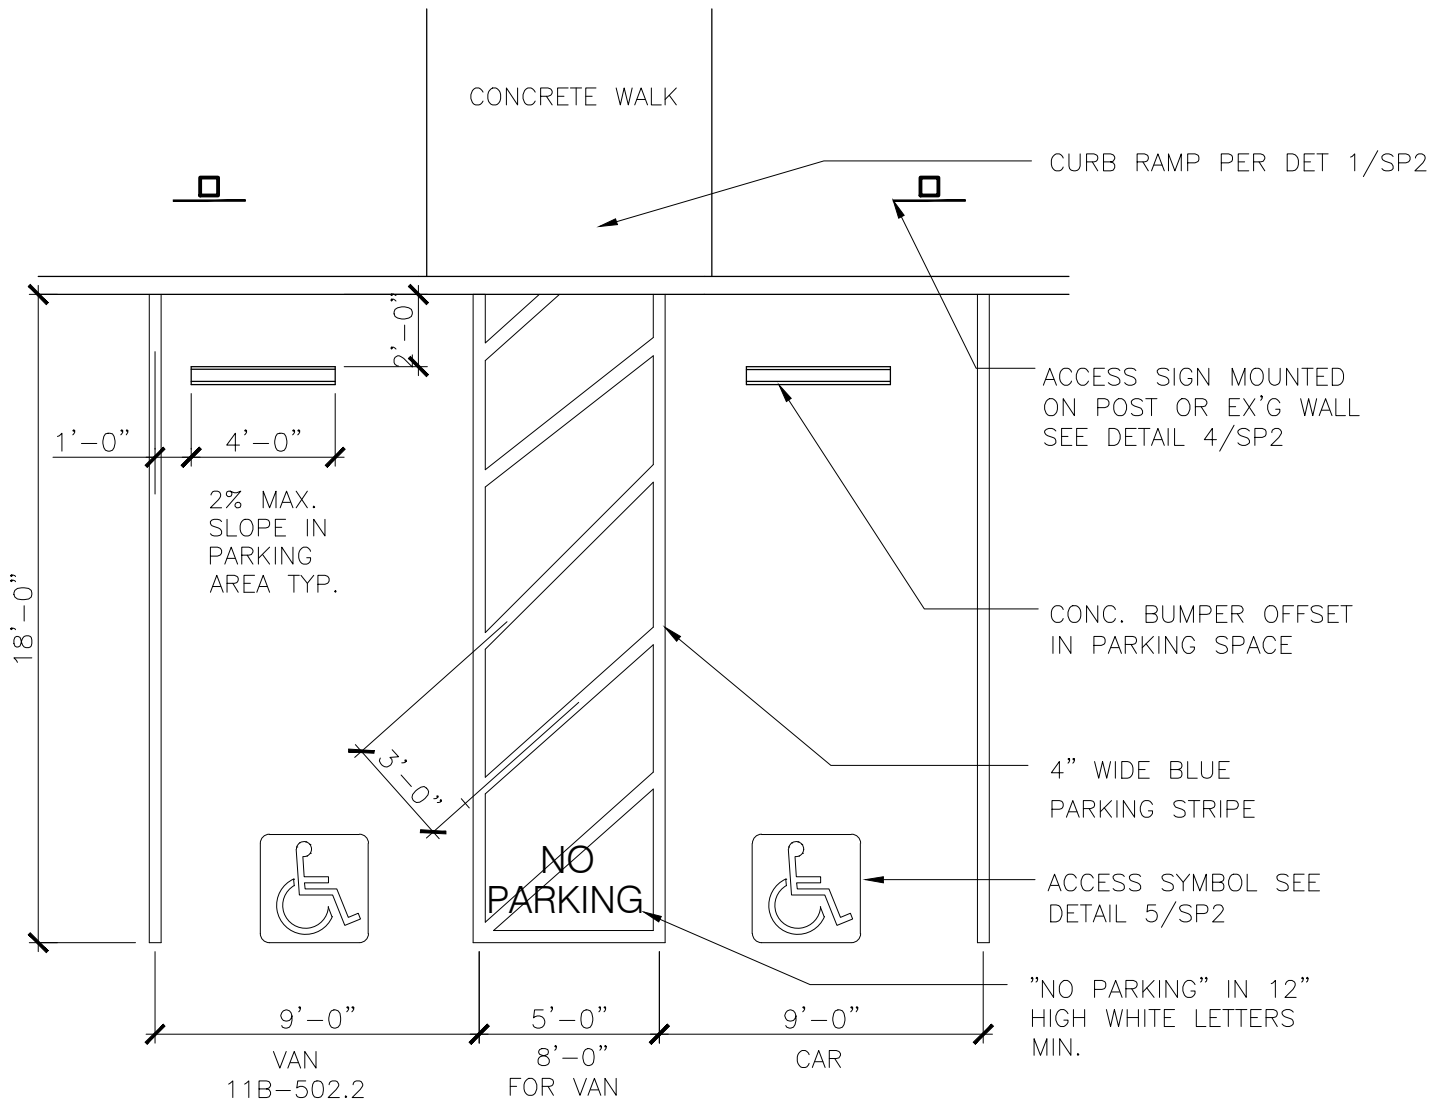

NOTE:
 PROVIDE VAN PARKING IN 1:8 RATIO OF DISABLED PERSON PARKING SPACES
 2% MAX SLOPE ALL DI-RECTION IN PARKING SPACES

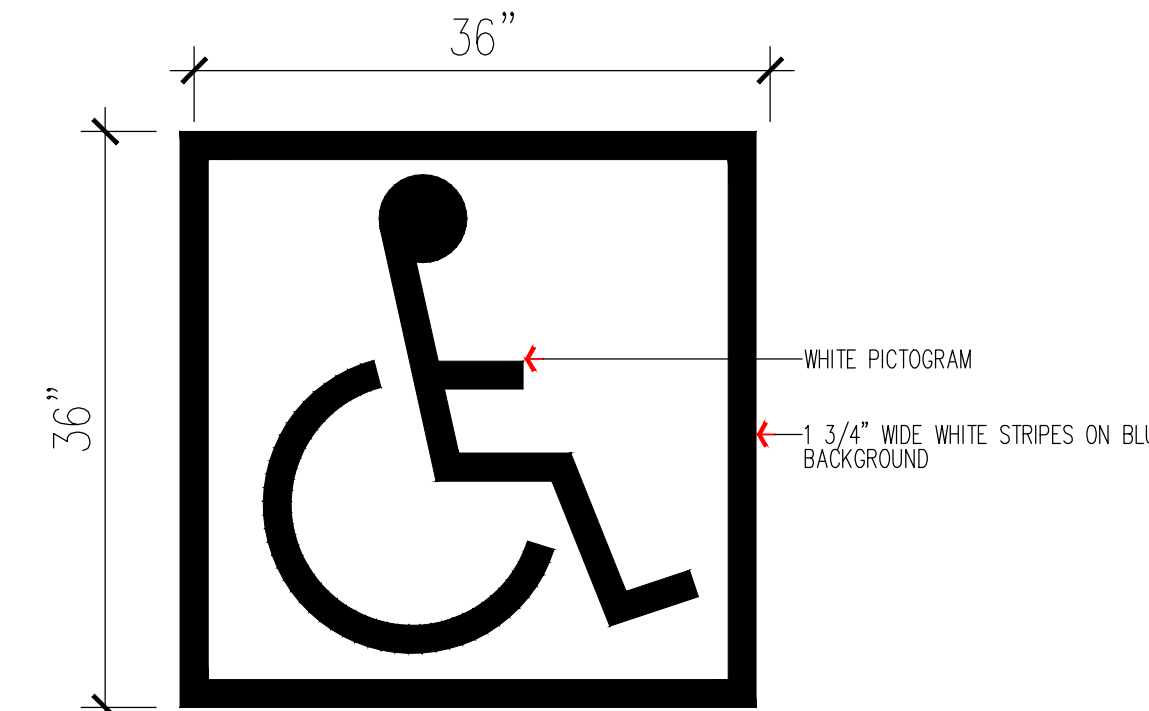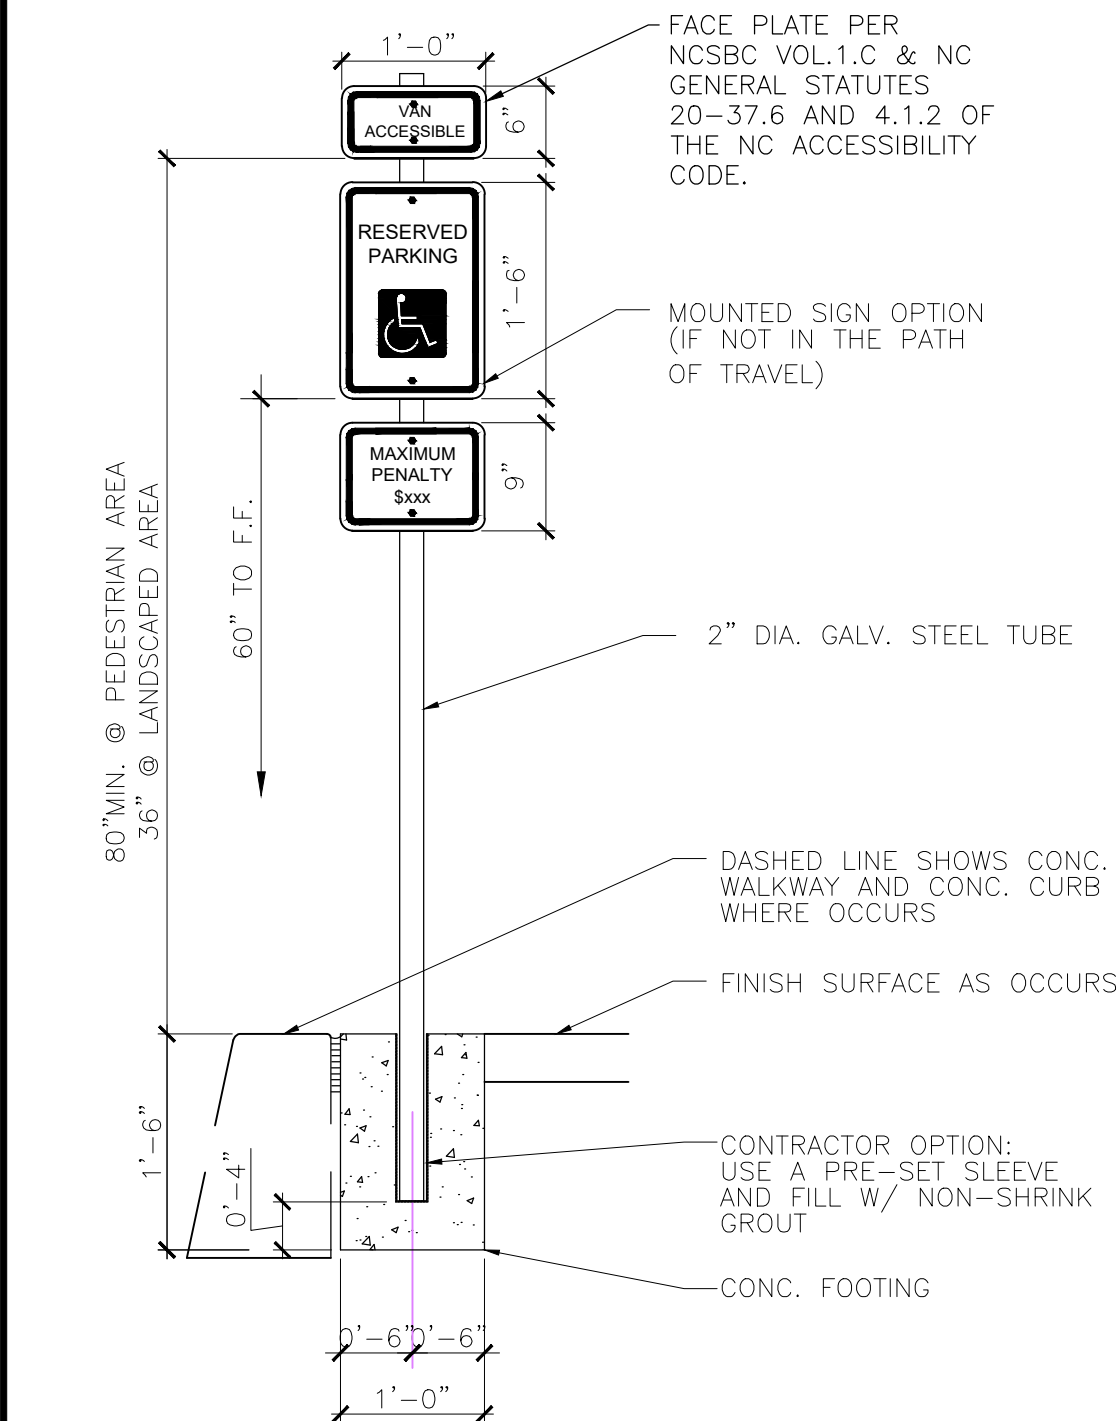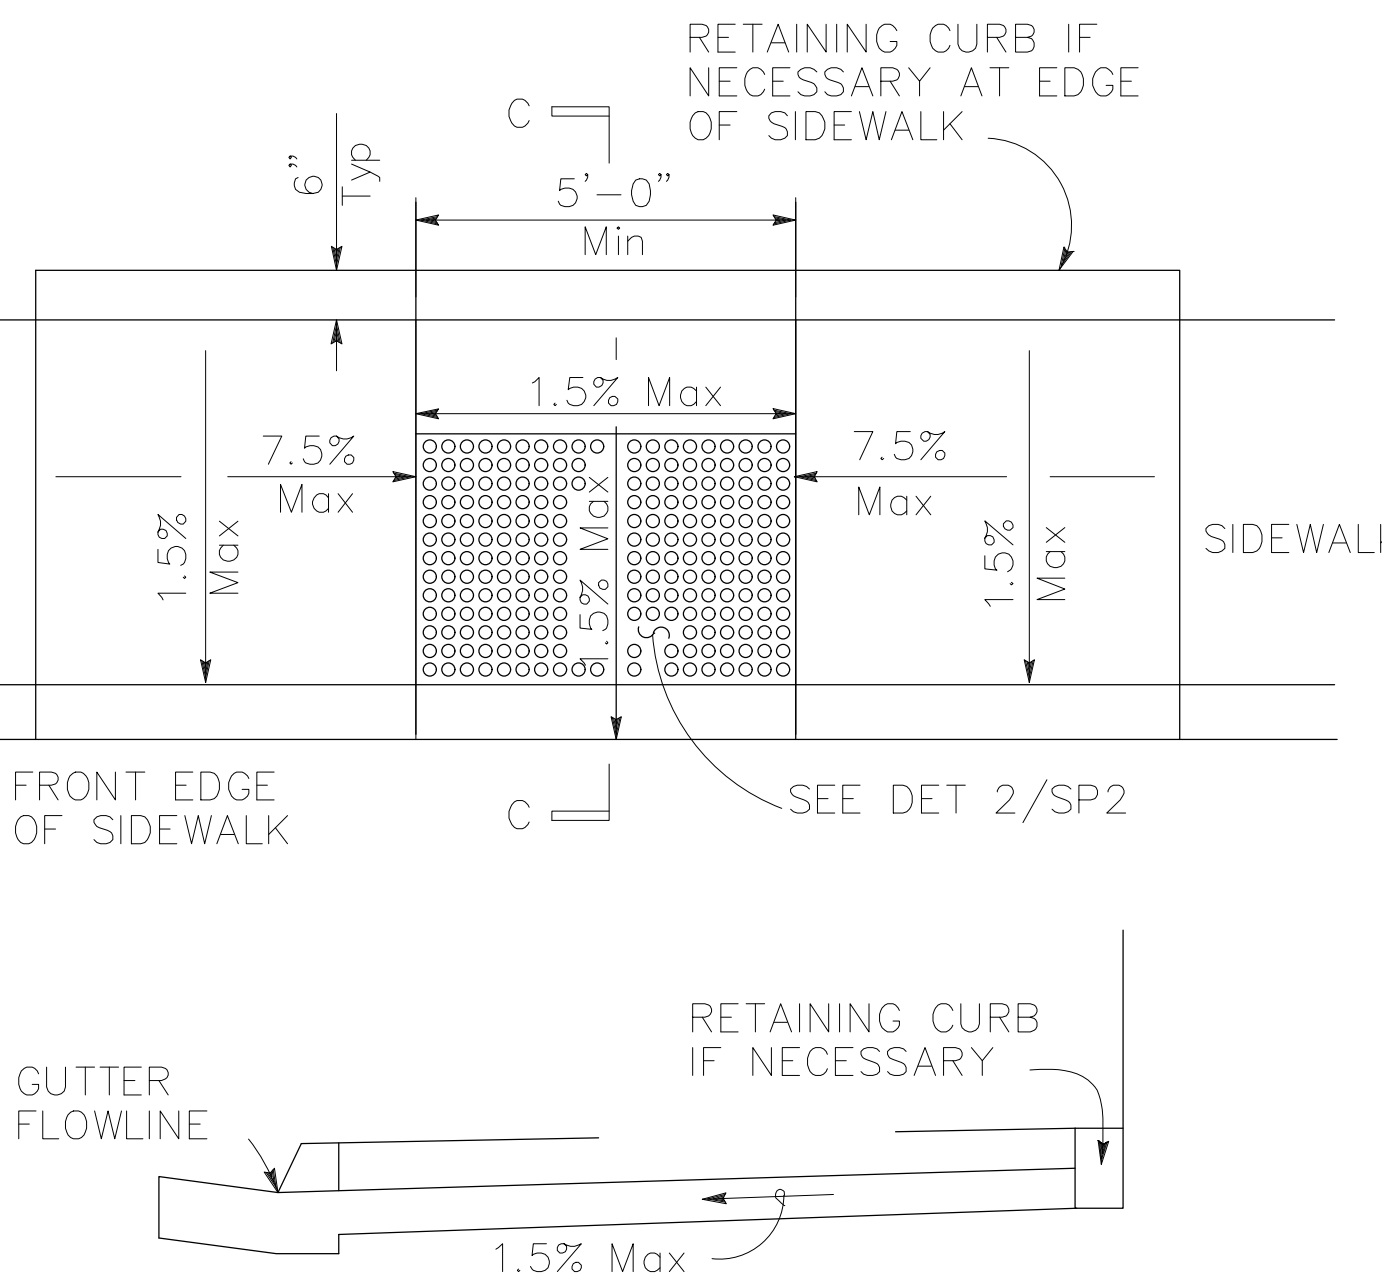


5 TYPICAL HANDICAP PARKING


6 ADA RAMP SCALE: 1/4" = 1'-0"

7 ADA PARKING SIGN

8 HANDICAP PARKING SYMBOL ON PAVEMENT

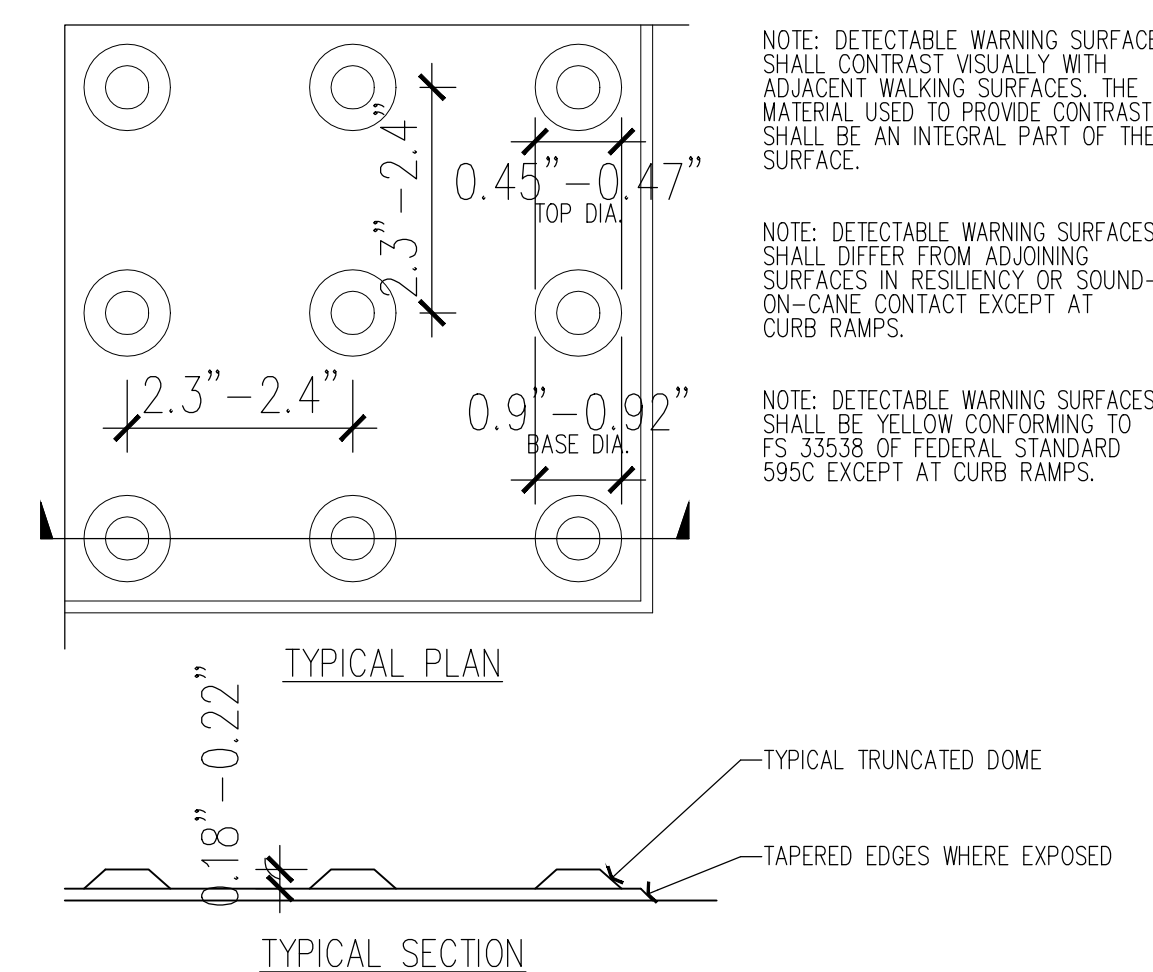

9 TRUNCATED DOMES

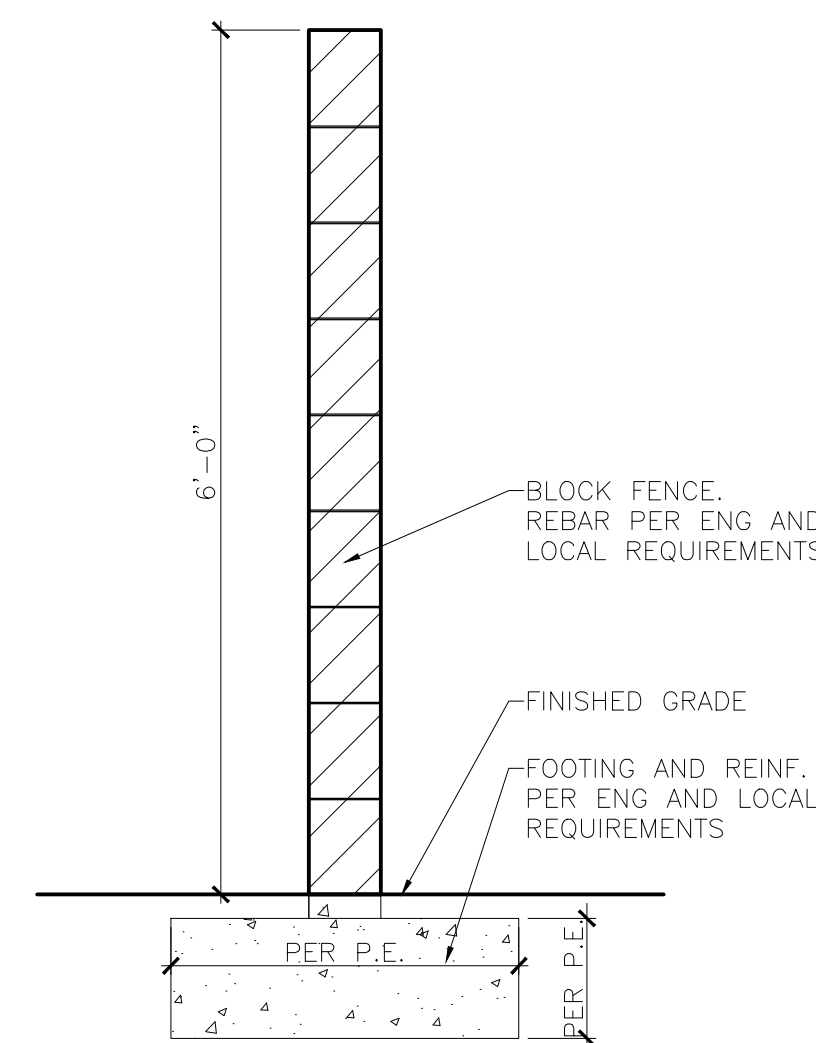

10 BLOCK FENCE SCALE: 3/4" = 1'-0"

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3	04/28/22	JS	REV'D SITE PLAN PER CITY COMMENTS
4	02/14/23	JS	REV TO ADD SP3 DETAILS TO PAGE
5	08/30/23	JS	REV PER CITY COMM.
6	10/20/23	NH	SITE REV'S
7	09/24/24	NH	ADD DTL TO PER CITY

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732035

DRAWN: JS
 CHECKED: NH
 DATE: 02/16/2023
 SP3

GENERAL NOTES

- THE CONTRACTOR SHALL BE RESPONSIBLE FOR THE CLEARING OF THE PROPOSED WORK AREA, AND RELOCATION COST OF ALL EXISTING UTILITIES. PERMITTEE MUST INFORM THE CITY OF CONSTRUCTION SCHEDULE AT LEAST 48 HOURS PRIOR TO BEGINNING OF CONSTRUCTION PHONE: (951)304-2489
- ALL WORK SHALL CONFORM TO THE REQUIREMENTS OF THE CITY OF MURRIETA PUBLIC WORKS DEPARTMENT IMPROVEMENT STANDARDS AND THE LATEST EDITION OF STANDARD SPECIFICATION FOR PUBLIC WORKS CONSTRUCTION (GREEN BOOK).
- THE DEVELOPER WILL INSTALL STREET NAME SIGNS CONFORMING TO CITY STANDARD NO. 601.
- CURB DEPRESSIONS AND DRIVEWAY APPROACHES WILL BE INSTALLED AND CONSTRUCTED ACCORDING TO CITY STANDARD NO. 308,309, OR 310, AS DIRECTED IN THE FIELD.
- BLUE RAISED REFLECTIVE PAVEMENT MARKERS SHALL BE PLACED TO MARK FIRE HYDRANT AND/OR WATER SUPPLY LOCATIONS AT THE DIRECTION OF THE CITY INSPECTOR FOLLOWING FINAL SEALANT AND STRIPING.
- WORK MAY NOT START UNTIL PERMITS HAVE BEEN OBTAINED.
- THE CONTRACTOR SHALL VERIFY ALL UTILITY LOCATIONS WITH UNDERGROUND SERVICE ALERT AT 811 AT LEAST TWO (2) WORKING DAYS PRIOR TO ANY EXCAVATION.
- ALL PAVEMENT SECTIONS ARE AT MINIMUM REQUIREMENTS. ADDITIONAL SOIL TEST SHALL BE TAKEN AFTER ROUGH GRADING TO DETERMINE THE EXACT STRUCTURAL SECTION REQUIREMENTS. USE STANDARD NO. 320 IF EXPANSIVE SOIL ARE ENCOUNTERED.
- DUST CONTROL SHALL BE MAINTAINED AT ALL TIMES BY WATER OR OTHER APPROVED METHODS.
- EQUIPMENT AND MATERIALS SHALL BE STORED IN A NEAT AND PROTECTED MANNER.
- THE CONTRACTOR WILL CONDUCT HIS OPERATIONS AS TO OFFER THE LEAST POSSIBLE OBSTRUCTION AND INCONVENIENCE TO PUBLIC TRAFFIC, AND HE SHALL HAVE UNDER CONSTRUCTION NO GREATER LENGTH OR AMOUNT OF WORK THAN HE CAN EXECUTE PROPERLY. ON EXISTING ROADS, TRAFFIC SHALL BE PERMITTED TO PASS THROUGH THE WORK AREA WITH AS LITTLE INCONVENIENCE AND DELAY AS POSSIBLE.
- EXISTING TRAFFIC SIGNALS AND LIGHTING SYSTEMS SHALL BE KEPT IN OPERATION FOR THE BENEFIT OF THE TRAVELING PUBLIC, AND TO MINIMIZE ANY INTERFERENCE WITH ROUTINE MAINTENANCE OF EXISTING SYSTEMS DURING WORK PROGRESS.
- WHENEVER THE CONTRACTOR'S OPERATION CREATES A HAZARDOUS CONDITION TO TRAFFIC OR TO THE PUBLIC, HE SHALL FURNISH AT HIS OWN EXPENSE, SUCH FLAGMEN AND GUARDS AS ARE NECESSARY TO GIVE ADEQUATE WARNING TO THE PUBLIC OF ANY DANGEROUS CONDITIONS. HE SHALL ALSO FURNISH, ERECT AND MAINTAIN SUCH FENCES BARRICADES, LIGHTS, SIGNS, AND OTHER DEVICES NECESSARY TO PREVENT ACCIDENTS AND INJURY TO THE PUBLIC.
- WHERE SURVEY MONUMENTS EXIST, SUCH MONUMENTS WILL BE PROTECTED OR SHALL BE REFERENCED AND RESET, PURSUANT TO BUSINESS AND PROFESSIONS CODE, SECTION 8700 TO 8805 (LAND SURVEYOR'S ACT).
- WHERE NEW A.C. PAVEMENT JOIN EXISTING PAVEMENT, SAWCUT TO A NEAT EDGE. THE SAWCUTS MUST BE PERPENDICULAR, PARALLEL OR RADIAL TO THE ROADWAY CENTERLINE. OVERLAY AND FEATHER NEW A.C. PAVEMENT TO PROVIDE SMOOTH TRANSITION.
- ALL EXISTING STREET SIGNS, ROADSIDE MARKERS ETC., SHALL BE PROTECTED AND/OR REPLACED IN KIND TO THE CURRENT CITY STANDARD PLANS AND CURRENT TRAFFIC MANUAL, AT NO COST TO THE CITY.
- ASPHALTIC EMULSION (FOG SEAL) SHALL BE APPLIED NOT LESS THAN FOURTEEN (14) DAYS FOLLOWING PLACEMENT OF THE ASPHALT SURFACING, AND SHALL BE APPLIED AT A MIN. RATE OF 0.05 GALLON PER SQUARE YARD. ASPHALTIC EMULSION SHALL CONFORM TO SECTION 37, 39, AND 94 OF THE STATE STANDARD SPECIFICATIONS.
- ALL UNDERGROUND FACILITIES, WITH LATERALS SHALL BE IN PLACE PRIOR TO PAVING THE STREET SECTION INCLUDING, BUT NOT LIMITED TO, THE FOLLOWING: WATER, SEWER, GAS, ELECTRIC, CABLE T.V., TELEPHONE, AND DRAINAGE.
- THE EXISTENCE AND LOCATION OF ANY UNDERGROUND UTILITY PIPES OR STRUCTURES SHOWN ON THESE PLANS WERE OBTAINED BY A SEARCH OF THE AVAILABLE RECORDS. TO THE BEST OF OUR KNOWLEDGE, THERE ARE NO EXISTING UTILITIES EXCEPT AS SHOWN ON THESE PLANS. THE CONTRACTOR IS REQUIRED TO TAKE DUE PRECAUTIONARY MEASURES TO PROTECT ALL UTILITY LINES, INCLUDING ANY OTHER LINES NOT SHOWN ON THESE PLANS OR NOT OF RECORD.
- IT SHALL BE THE RESPONSIBILITY OF THE CONTRACTOR TO APPLY TO THE CITY OF MURRIETA ENGINEERING DEPARTMENT, FOR AN ENCROACHMENT PERMIT FOR ALL WORK ON EXISTING CITY MAINTAINED ROADS, AND FOR UTILITY WORK WITHIN OFFERS OF DEDICATION FOR PUBLIC USE.
- IT SHALL BE THE RESPONSIBILITY OF THE CONTRACTOR TO NOTIFY THE ENGINEER TO INSTALL STREET CENTERLINE MONUMENTS AS REQUIRED BY CITY STANDARD DRAWINGS NO. 616, 617, AND 618.
- STREET LIGHTS SHALL BE INSTALLED IN ACCORDANCE WITH THE CITY OF MURRIETA STANDARD NO. 619 OR 620.
- APPROVAL OF THESE PLANS BY THE CITY OR ITS AGENTS DOES NOT RELIEVE THE APPLICANT AND HIS ENGINEER FROM THE RESPONSIBILITY FOR THE CORRECTION OF ERRORS OR OMISSIONS DISCOVERED DURING CONSTRUCTION. UPON REQUEST, THE APPROPRIATE PLAN REVISIONS SHALL BE PROMPTLY SUBMITTED TO THE CITY ENGINEER FOR REVIEW AND APPROVAL.
- ALL GTE, SCE AND SCG FACILITIES WILL BE RELOCATED OR MODIFIED BY THE RESPECTIVE UTILITIES OR THEIR APPOINTED REPRESENTATIVES.
- ALL WATER RELATED WORK SHALL BE DONE IN ACCORDANCE WITH THE SERVICING WATER DISTRICT STANDARDS AND SPECIFICATIONS.
- ALL SEWER RELATED WORK SHALL BE DONE IN ACCORDANCE WITH THE SERVICING WATER DISTRICT STANDARDS AND SPECIFICATIONS.
- ANY SERVICE SHUT DOWN SHALL BE DONE AT NIGHT, PRIOR TO ANY SHUT DOWN, THE CONTRACTOR SHALL NOTIFY THE DIRECTOR, ENGINEER, CUSTOMER, FIRE DEPARTMENT, SERVICING WATER DISTRICT, AND ALL OTHERS AFFECTED BY THE SHUT DOWN A MINIMUM OF TWO (2) WEEKS IN ADVANCE.
- IT SHALL BE THE RESPONSIBILITY OF THE DEVELOPER OR CONTRACTOR TO APPLY TO CALIFORNIA DEPARTMENT OF TRANSPORTATION (CALTRANS) FOR AN ENCROACHMENT PERMIT FOR ALL WORK PERFORMED WITHIN THE STATE RIGHT-OF-WAY.
- 24 HOUR EMERGENCY CONTACT: _____ CELL: _____





PRELIMINARY GRADING PLAN

PARCEL 3 & 4 OF PARCEL MAP 7654, IN THE CITY OF MURRIETA, COUNTY OF RIVERSIDE, STATE OF CALIFORNIA AS PER MAP THEREOF ON FILE IN BOOK 25, PAGE 82 OF PARCEL MAPS, IN THE OFFICE OF THE COUNTY RECORDER OF SAID COUNTY.
APN 949-220-013/014, MURRIETA, CA 92562

GRADING NOTES

- ALL GRADING SHALL CONFORM TO THE CITY OF MURRIETA GRADING CODE AND MANUAL.
- MINIMUM BUILDING PAD AND DRAINAGE SWALE SLOPE SHALL BE 1% DRAINAGE SWALES SHALL BE A MINIMUM OF 0.2' DEEP AND BE CONSTRUCTED A MINIMUM OF 2' FROM THE TOP OF CUT OR FILL SLOPES.
- MAXIMUM CUT AND FILL SLOPE = 2:1.
- PROVIDE 4' WIDE BY 1' HIGH BERM OR EQUIVALENT ALONG THE TOP OF ALL FILL SLOPES OVER 5' HIGH.
- ALL GRADING SHALL BE DONE UNDER THE SUPERVISION OF A COMPETENT SOILS ENGINEER WHO SHALL CERTIFY THAT ALL FILL HAS BEEN PROPERLY PLACED AND WHO SHALL SUBMIT A FINAL COMPACTION REPORT FOR ALL FILLS OVER 1' DEEP.
- A REGISTERED CIVIL ENGINEER SHALL SUBMIT TO THE CITY ENGINEERING DEPARTMENT WRITTEN CERTIFICATION OF COMPLETION OF ROUGH GRADING IN ACCORDANCE WITH THE APPROVED GRADING PLAN PRIOR TO ISSUANCE OF THE BUILDING PERMIT. CERTIFICATION SHALL BE TO LINE, GRADE, ELEVATION AND LOCATION OF CUT/FILL SLOPES.
- PROVIDE A BROW DITCH, DESIGNED TO HANDLE 100 YEAR Q STORM FLOWS, ALONG TOP CUT OF SLOPE.
- ALL GRADING SHALL BE DONE IN CONFORMANCE WITH RECOMMENDATIONS OF THE PRELIMINARY SOILS INVESTIGATION BY EARTH STRATA GEOTECHNICAL SERVICES, INC. DATED 8/28/2018. TWO SETS OF THE FINAL COMPACTION REPORT SHALL BE SUBMITTED TO THE ENGINEERING DEPARTMENT WHICH SHALL INCLUDE FOUNDATION DESIGN RECOMMENDATIONS AND CERTIFICATION THAT GRADING HAS BEEN DONE IN CONFORMANCE WITH THE RECOMMENDATIONS OF THE PRELIMINARY SOILS REPORT.
- THE CONTRACTOR SHALL NOTIFY THE CITY OF MURRIETA ENGINEERING DEPARTMENT AT LEAST 24 HOURS IN ADVANCE REQUESTING FINISH LOT GRADE AND DRAINAGE INSPECTION. THIS INSPECTION MUST BE APPROVED PRIOR TO BUILDING PERMIT FINAL INSPECTION FOR EACH LOT.
- CUT SLOPES EQUAL TO OR GREATER THAN 5' IN VERTICAL HEIGHT AND FILL SLOPES EQUAL TO OR GREATER THAN 3' IN VERTICAL HEIGHT SHALL BE PLANTED WITH GRASS OR GROUND COVER TO PROTECT THE SLOPE FROM EROSION AND INSTABILITY IN ACCORDANCE WITH THE CITY GRADING CODE PRIOR TO THE APPROVAL OF FINAL INSPECTION.
- NO FILL SHALL BE PLACED ON EXISTING GROUND UNTIL THE GROUND HAS BEEN CLEARED OF WEEDS, DEBRIS, TOPSOIL, AND OTHER DELETERIOUS MATERIAL.
- IF STEEP SLOPING TERRAIN OCCURS UPON WHICH FILL IS TO BE PLACED, IT MUST BE CLEARED, KEYED, AND BENCHED INTO FIRM NATURAL SOIL FOR FULL SUPPORT. PREPARATION SHALL BE APPROVED BY A REGISTERED ENGINEER PRIOR TO PLACEMENT OF FILL MATERIAL.
- DURING ROUGH GRADING OPERATIONS AND PRIOR TO CONSTRUCTION OF PERMANENT DRAINAGE STRUCTURES TEMPORARY DRAINAGE CONTROL SHOULD BE PROVIDED TO PREVENT PONDING WATER AND DAMAGE TO ADJACENT PROPERTIES.
- DUST SHALL BE CONTROLLED BY WATER OR OTHER APPROVED METHODS.
- ALL EXISTING DRAINAGE COURSES ON THE PROJECT SITE MUST CONTINUE TO FUNCTION, ESPECIALLY DURING STORM CONDITIONS. PROTECTIVE MEASURES AND TEMPORARY DRAINAGE PROVISIONS MUST BE USED TO PROTECT ADJOINING PROPERTIES DURING GRADING OPERATIONS.
- STABILITY CALCULATIONS WITH A FACTOR OF AT LEAST ONE AND FIVE TENTHS (1.5) SHALL BE SUBMITTED BY A SOILS ENGINEER TO THE CITY ENGINEERING DEPARTMENT FOR CUT AND FILL SLOPES OVER 30' IN VERTICAL HEIGHT.

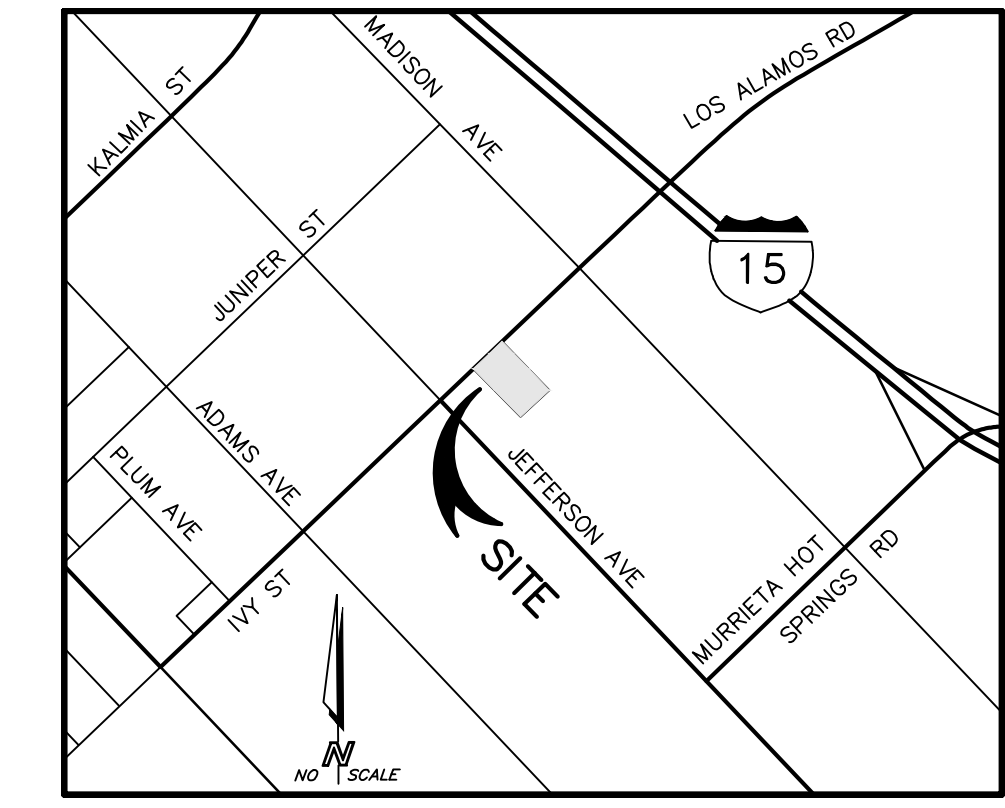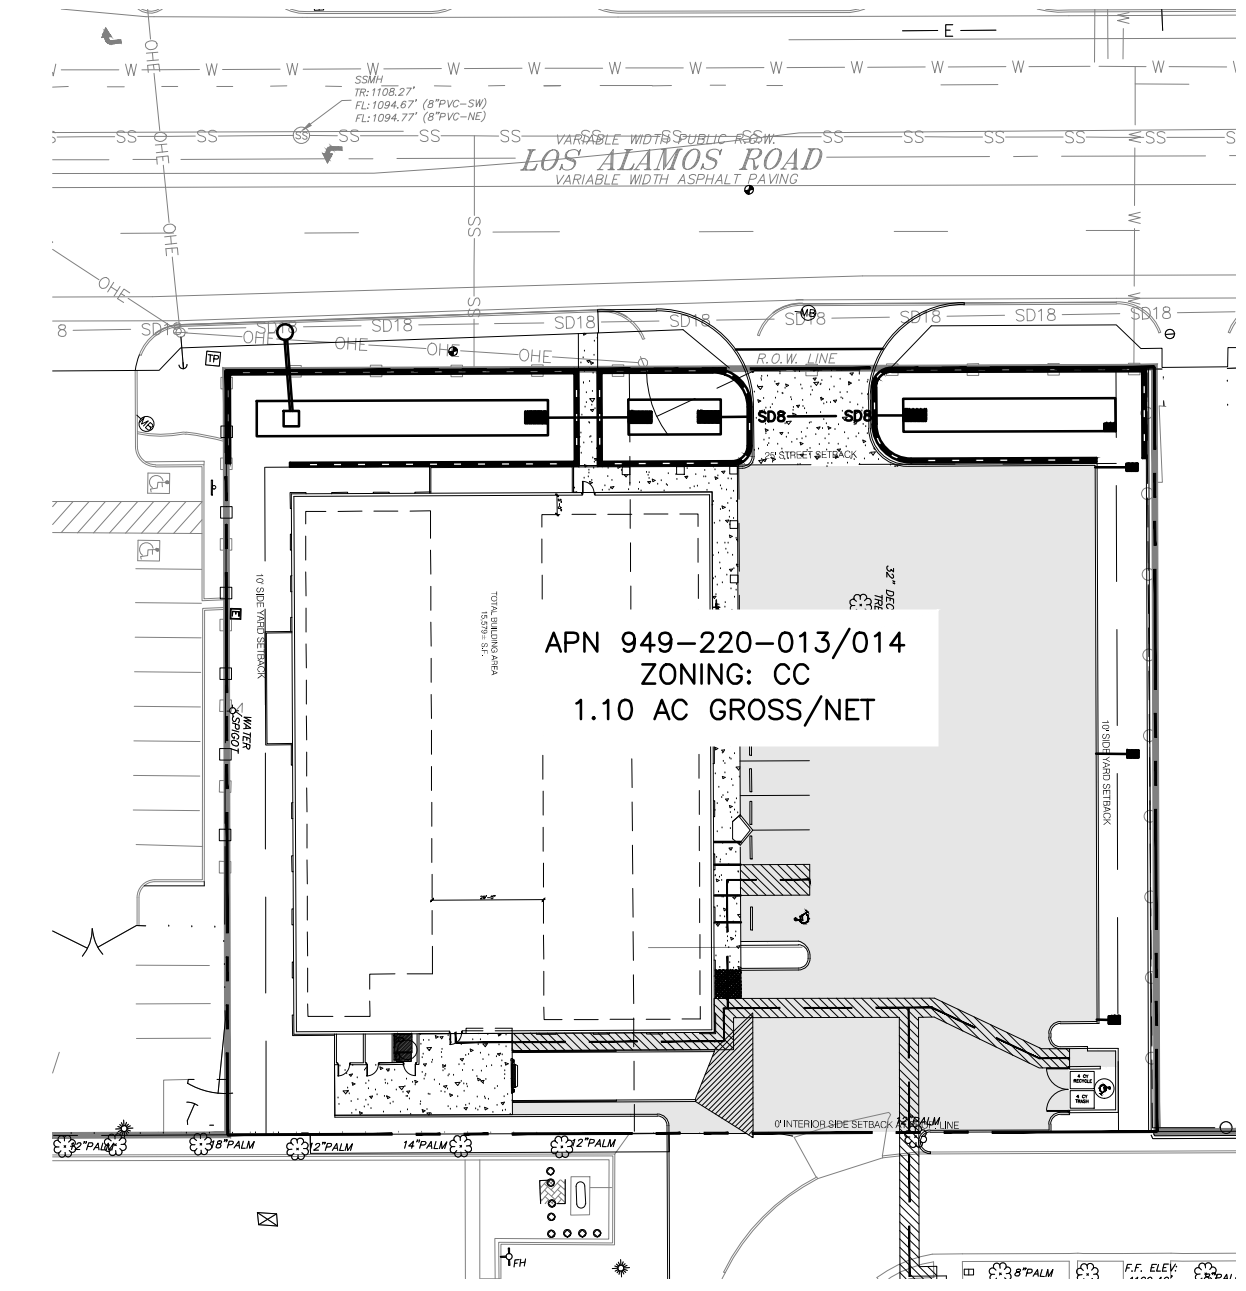

VICINITY MAP
T:7S, R:3W
NO SCALE

CONSTRUCTION NOTES

- INFILTRATION BASIN PER WOMP.
- 48 X 48 JENSEN PRECAST DROP INLET W/ FRAME & GRATE. 18" RCP LATERAL CONNECTED TO (E) RCP STORMDRAIN. SEE DETAIL HEREON.
- RETAINING BLOCK WALL. HEIGHT VARIES. MAX HEIGHT: 5'
- CONSTRUCT 12" BROOKS BOX OR APPROVED EQUAL.
- INSTALL NDS TRENCH DRAIN.
- CONSTRUCT ADA RAMP PER CALTRANS AB8A, CASE C.
- CONSTRUCT 4-INCH ROLLED CURB PER AMERCO STANDARD DETAIL CP-2.
- CONSTRUCT DRIVEWAY APPROACH PER CITY OF MURRIETA STANDARD 310C.
- CONSTRUCT RIPRAP ENERGY DISSIPATER PER DETAIL HEREON.
- CONSTRUCT TRADITIONAL ASPHALT PAVEMENT SECTION PER GEOTECHNICAL RECOMMENDATIONS
- FIRE LANES:
6.5" OF ASPHALT OVER 16" OF CLASS-II AB.
- CONSTRUCT EARTHEN SWALE PER DETAIL HEREON.
- INSTALL 8-INCH HDPE STORMDRAIN.

"DECLARATION OF RESPONSIBLE CHARGE"

I HEREBY DECLARE THAT I AM THE ENGINEER OF WORK FOR THIS PROJECT, THAT I HAVE EXERCISED RESPONSIBLE CHARGE OVER THE DESIGN OF THE PROJECT AS DEFINED IN SECTION 6703 OF THE BUSINESS AND PROFESSIONS CODE. AND THAT THE DESIGN IS CONSISTENT WITH CURRENT STANDARDS.

I UNDERSTAND THAT THE CHECK OF PROJECT DRAWINGS AND SPECIFICATION BY THE CITY OF MURRIETA IS CONFINED TO A REVIEW ONLY AND DOES NOT RELIEVE ME, AS ENGINEER OF WORK, OF MY RESPONSIBILITIES FOR PROJECT DESIGN.

ENGINEER COMPANY NAME: IE SURVEY & ENGINEERING, INC.
 ADDRESS: 41146 ELM STREET, SUITE G
 ADDRESS: MURRIETA, CA 92562
 PHONE NO.: 951-698-1830

ALEX R. PAULSEN
 ENGINEER'S NAME PRINTED _____ DATE _____



OWNER:
 24-HOUR CONTACT
 AMERCO REAL ESTATE
 c/o MR. TRAVIS COCHRAN
 2727 NORTH CENTRAL AVENUE
 PHOENIX, AZ 85004
 EMAIL: travis_cochran@kmail.com
 PHONE: (626) 274-5578

GEOTECHNICAL ENGINEER:
 NINYO & MOORE, GEOTECHNICAL & ENVIRONMENTAL SCIENCES CONSULTANTS
 5710 RUFFIN ROAD, SAN DIEGO, CA, 92123
 CHRISTINA A. TRETIJAK, PE, CEG No. 26590
 PHONE: 858-576-1000

EARTHWORK QUANTITIES	
CUT:	3,308 Cu. Yds.
FILL:	3,308 Cu. Yds.
BALANCE:	0 Cu. Yds.

GRADING NOTES (CONTD.)

- A REGISTERED CIVIL ENGINEER OR LICENSED LAND SURVEYOR SHALL SUBMIT CERTIFICATION OF BUILDING PAD ELEVATION. WHERE SPECIFIC ELEVATIONS ARE REQUIRED, THE ELEVATION (WITH RESPECT TO MEAN SEA LEVEL) SHALL BE GIVEN. IF AN ELEVATION WITH RESPECT TO ADJACENT GROUND SURFACE IS REQUIRED, THE ACTUAL DISTANCE ABOVE THE ADJACENT GROUND SHALL BE GIVEN.
- EROSION CONTROL: ALL GRADED SLOPES SHALL BE PLANTED WITH AN APPROVED GROUND COVER. SLOPES OVER 15' IN VERTICAL HEIGHT, IN ADDITION TO GROUND COVER, SHALL BE PLANTED WITH APPROVED TREES, SHRUBS, OR COMBINATIONS, 15' ON CENTERS. SLOPES OVER 4' IN VERTICAL HEIGHT SHALL HAVE PERMANENT IRRIGATION SYSTEMS WITH BACKFLOW PREVENTION DEVICES PER U.P.C., CHAPTER 10.R.
- FINISH GRADE SHALL BE SLOPED AWAY FROM ALL EXTERIOR WALLS AT NOT LESS THAN 2% PER FOOT FOR A MINIMUM OF 3 FEET.
- "NO OBSTRUCTION OF FLOOD PLAINS OR NATURAL WATER COURSES SHALL BE PERMITTED."
- ALL PROPERTY CORNERS SHALL BE CLEARLY DELINEATED IN THE FIELD PRIOR TO COMMENCEMENT OF ANY CONSTRUCTION/GRADING.
- WORK MAY NOT START UNTIL PERMITS HAVE BEEN OBTAINED.
- PURSUANT TO THE CITY OF MURRIETA MUNICIPAL CODE 15.52.150, GRADING AND EQUIPMENT OPERATION WITHIN ONE-HALF (1/2) MILE OF A STRUCTURE FOR HUMAN OCCUPANCY SHALL NOT BE CONDUCTED BETWEEN THE HOURS OF 8:00 PM AND 7:00 AM, NOR ON SUNDAY AND FEDERAL HOLIDAYS WITHOUT THE APPROVAL OF THE CITY ENGINEER.
- APPROVAL OF THESE PLANS BY THE CITY OR ITS AGENTS DOES NOT RELIEVE THE APPLICANT AND HIS ENGINEER FROM THE RESPONSIBILITY FOR THE CORRECTION OF ERRORS OR OMISSIONS DISCOVERED DURING CONSTRUCTION. UPON REQUEST, THE APPROPRIATE PLAN REVISIONS SHALL BE PROMPTLY SUBMITTED TO THE CITY ENGINEER FOR REVIEW APPROVAL.
- SOURCE OF TOPOGRAPHY: AERIAL PHOTOGRAPHY/SURVEY PERFORMED ON FEBRUARY 8, 2018.
- SEPARATE HAUL PERMIT IS REQUIRED FOR ANY IMPORT/EXPORT OF MATERIAL TO/FROM PROJECT SITE.
- THE CONTRACTOR SHALL SCHEDULE A PRE-CONSTRUCTION MEETING WITH THE CITY LANDSCAPE ARCHITECT AT LEAST 48 HOURS PRIOR TO POURING ANY CONCRETE CURBS IN PLANTER AREAS. THE CITY LANDSCAPE ARCHITECT'S PHONE NUMBER IS (951)698-0122.
- THE APPLICANT IS HEREBY NOTICED THAT THEY COMPLY WITH ALL STATE AND FEDERAL ENDANGERED SPECIES LAW. THE CITY OF MURRIETA IS NOT RESPONSIBLE FOR ANY SUCH VIOLATION OF STATE OR FEDERAL ENDANGERED SPECIES LAW DUE TO THE APPLICANT'S NON-COMPLIANCE.
- IN CASE OF EMERGENCY, 24 HOUR CONTACT IS _____

EROSION CONTROL NOTES

- IN CASE OF EMERGENCY, CALL: _____ CELL: _____
- EQUIPMENT AND WORKERS FOR EMERGENCY WORK SHALL BE MADE AVAILABLE AT ALL TIMES DURING THE RAINY SEASON. NECESSARY MATERIALS SHALL BE AVAILABLE ON SITE AND STOCKPILED AT CONVENIENT LOCATIONS TO FACILITATE RAPID CONSTRUCTION OF TEMPORARY DEVICES WHEN RAIN IS IMMINENT.
- DEVICES SHALL NOT BE MOVED OR MODIFIED WITHOUT THE APPROVAL OF THE ENGINEERING DEPARTMENT.
- ALL REMOVABLE PROTECTIVE DEVICES SHOWN SHALL BE IN PLACE AT THE END OF EACH WORKING DAY WHEN THE 5-DAY RAIN PROBABILITY FORECAST EXCEEDS 40%.
- AFTER A RAINSTORM, ALL SILT AND DEBRIS SHALL BE REMOVED FROM CHECK BERMS AND DESILTING BASINS, AND THE BASINS PUMPED DRY.
- GRADED AREAS AROUND THE TRACT PERIMETER MUST DRAIN AWAY FROM THE FACE OF SLOPE AT THE CONCLUSION OF EACH WORKING DAY.
- THE CONTRACTOR SHALL BE RESPONSIBLE AND SHALL TAKE NECESSARY PRECAUTIONS TO PREVENT PUBLIC TRESPASS ONTO AREAS WHERE IMPOUNDED WATER CREATES A HAZARDOUS CONDITION.
- GRAVEL BAG LAYOUT SHALL BE INSTALLED AS SHOWN PER PLAN OR AS DIRECTED BY THE CITY INSPECTOR.




SITE AREA CALCULATIONS	
TOTAL SITE AREA:	1.11 ac. GROSS
TOTAL SITE AREA:	1.11 ac. NET
TOTAL DISTURBED AREA:	1.11 ac., 100%
IMPERVIOUSNESS AREA:	0.83 ac., 75%

BENCH MARK
 ELEVATIONS ARE BASED ON OPUS SOLUTION. DATUM IS NAVD 88.



A.P.N.:
 949-220-013
 949-220-014

"AS BUILT"	BASIS OF BEARING	RECOMMEND APPROVAL
THE RECEIPT OF AS - BUILT PLANS AND CITY'S ACCEPTANCE THEREOF DOES NOT ABSOLVE THE ENGINEER OF WORK OF ANY RESPONSIBILITY FOR THE PROJECT DESIGN.	CENTERLINE OF LOS ALAMOS ROAD BEING N47°47'54"E.	DATE: _____ WILLIAM G. BIXBY BUREAU VERITAS NORTH AMERICA, INC. R.C.E. NO. 48819
ENGINEER OF WORK: _____ DATE: _____ RCE NO. 87481		

	IE SURVEY & ENGINEERING, INC. 41146 ELM STREET, SUITE G MURRIETA, CA 92562 T: (951) 698-1830 E: INFO@IESURVEYANDENG.COM JOB NO. 20002	PLANS PREPARED UNDER SUPERVISION OF: _____ DATE: _____		DATE	INITIAL	REVISION DESCRIPTION	SHT. NO.	DATE	INITIAL	
		SCALE	AS SHOWN	AS SHOWN	ENGR OF WORK					
SHEET 1 CITY OF MURRIETA ENGINEERING DEPARTMENT SHEETS 3 TITLE SHEET APN 949-220-013/014 41450 LOS ALAMOS ROAD, MURRIETA RIVERSIDE COUNTY, CALIFORNIA APPROVED ROBERT K. MOEHLING _____ DATE _____ CITY ENGINEER RCE NO. 63056 DWN BY: ARP CHKD BY: ARP FELD BY: _____ PROJECT NO. _____										

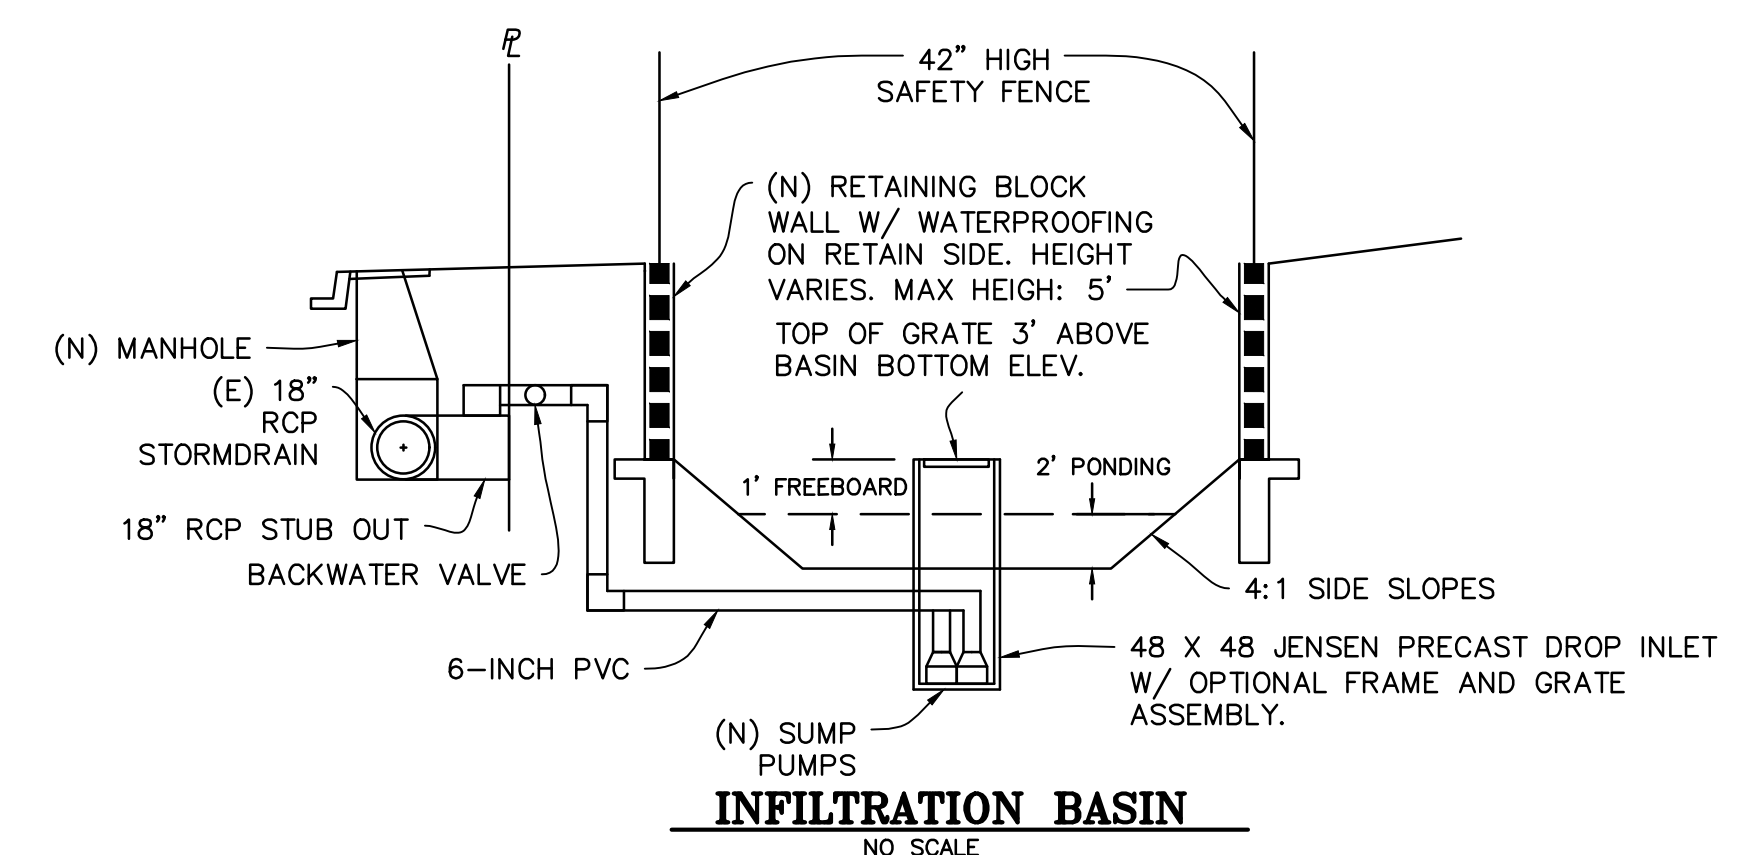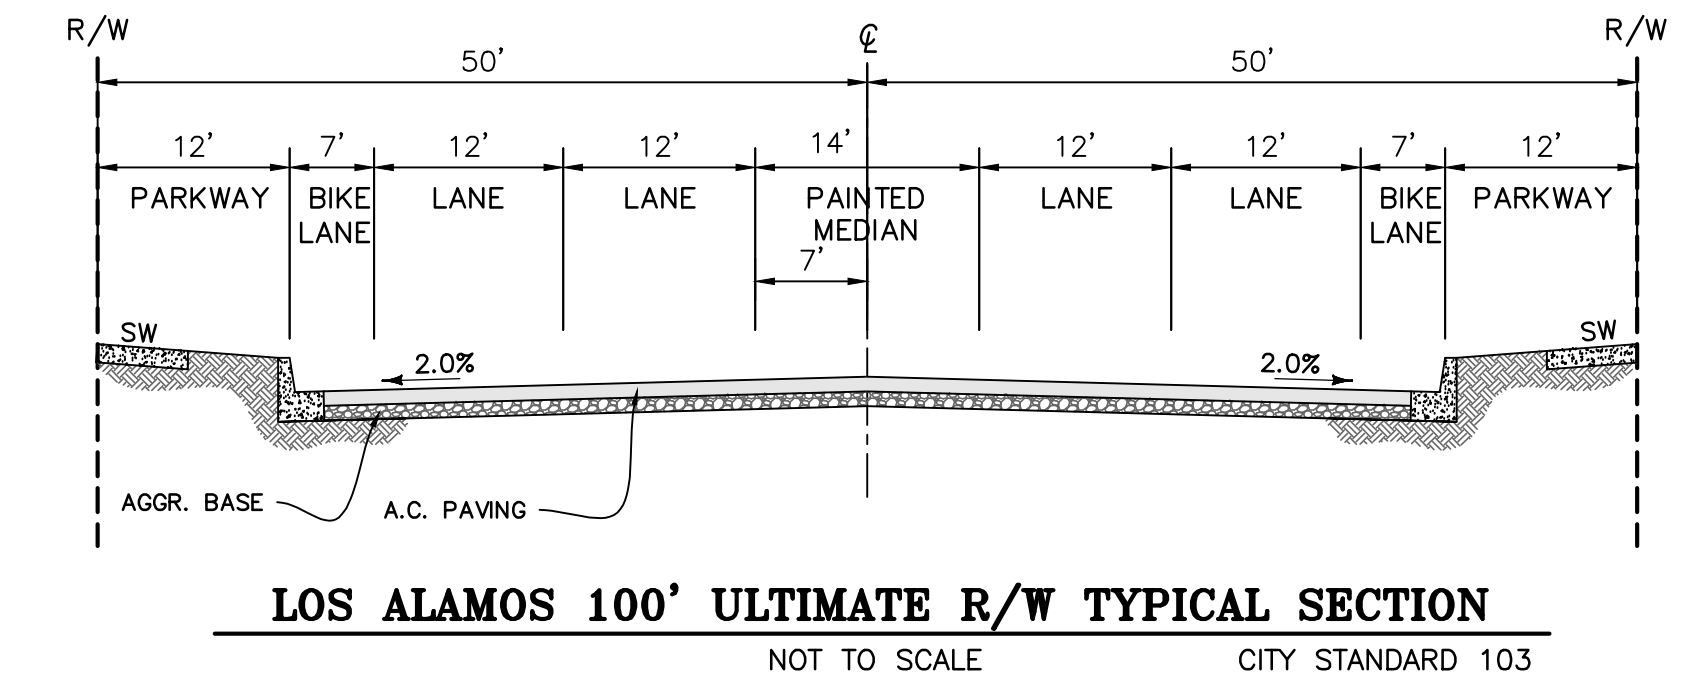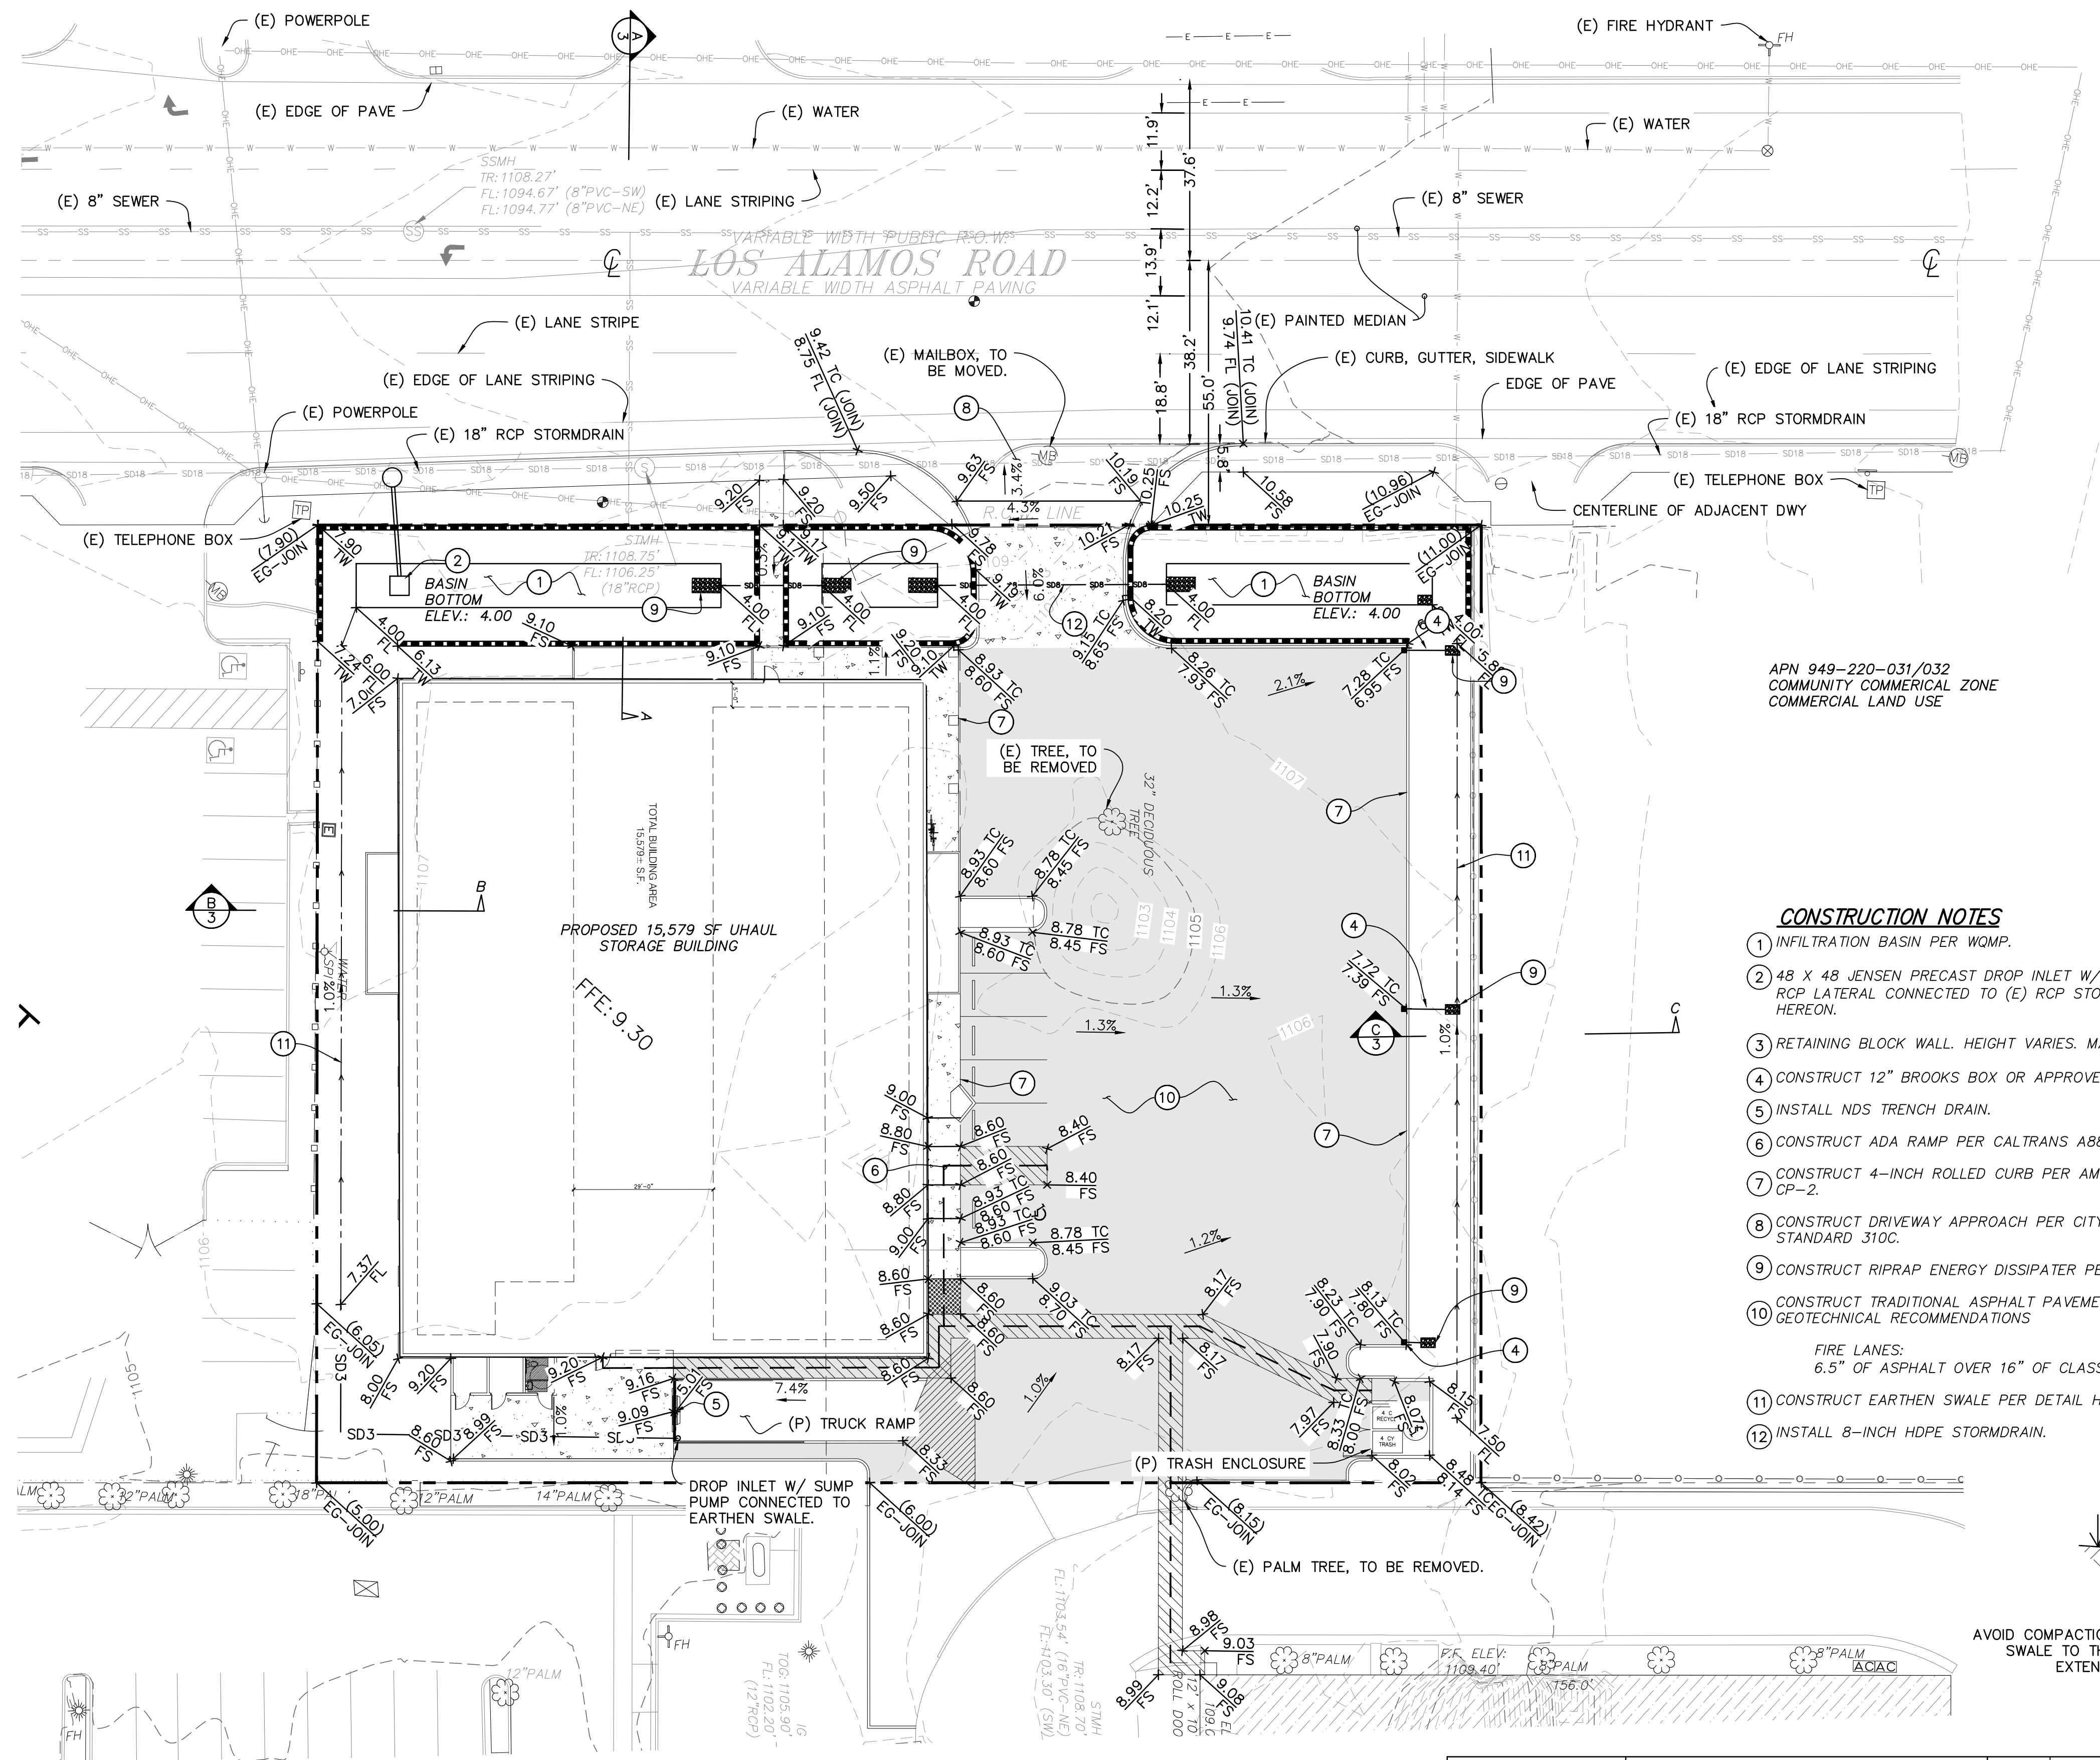

- CONSTRUCTION NOTES**
- 1 INFILTRATION BASIN PER WOMP.
 - 2 48 X 48 JENSEN PRECAST DROP INLET W/ FRAME & GRATE. 18" RCP LATERAL CONNECTED TO (E) RCP STORMDRAIN. SEE DETAIL HEREON.
 - 3 RETAINING BLOCK WALL. HEIGHT VARIES. MAX HEIGHT: 5'
 - 4 CONSTRUCT 12" BROOKS BOX OR APPROVED EQUAL.
 - 5 INSTALL NDS TRENCH DRAIN.
 - 6 CONSTRUCT ADA RAMP PER CALTRANS AB8A, CASE C.
 - 7 CONSTRUCT 4-INCH ROLLED CURB PER AMERCO STANDARD DETAIL CP-2.
 - 8 CONSTRUCT DRIVEWAY APPROACH PER CITY OF MURRIETA STANDARD 310C.
 - 9 CONSTRUCT RIPRAP ENERGY DISSIPATER PER DETAIL HEREON.
 - 10 CONSTRUCT TRADITIONAL ASPHALT PAVEMENT SECTION PER GEOTECHNICAL RECOMMENDATIONS
- FIRE LANES:
6.5" OF ASPHALT OVER 16" OF CLASS-II AB.
- 11 CONSTRUCT EARTHEN SWALE PER DETAIL HEREON.
 - 12 INSTALL 8-INCH HDPE STORMDRAIN.

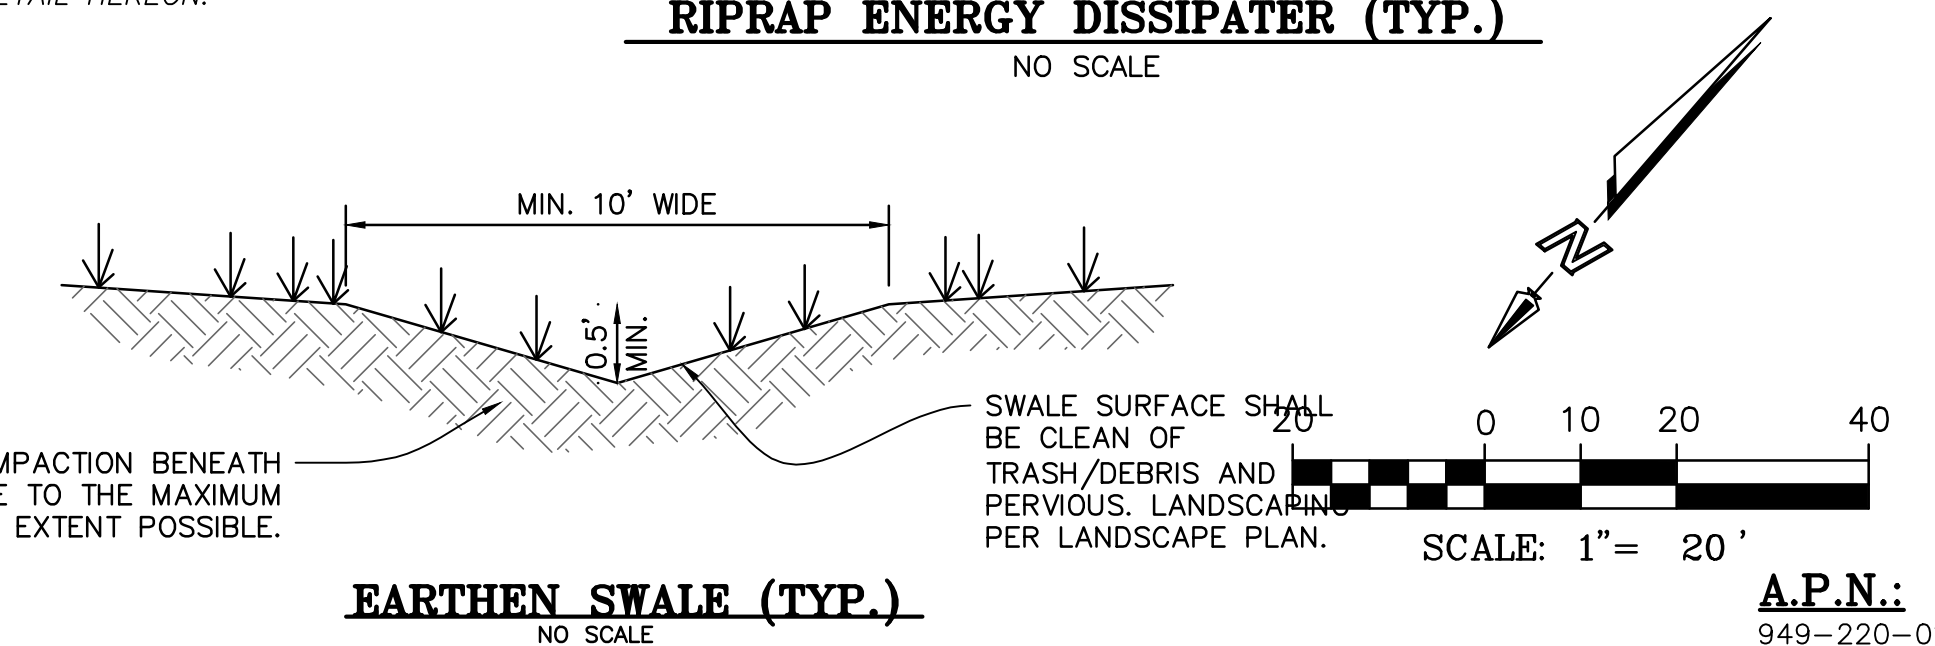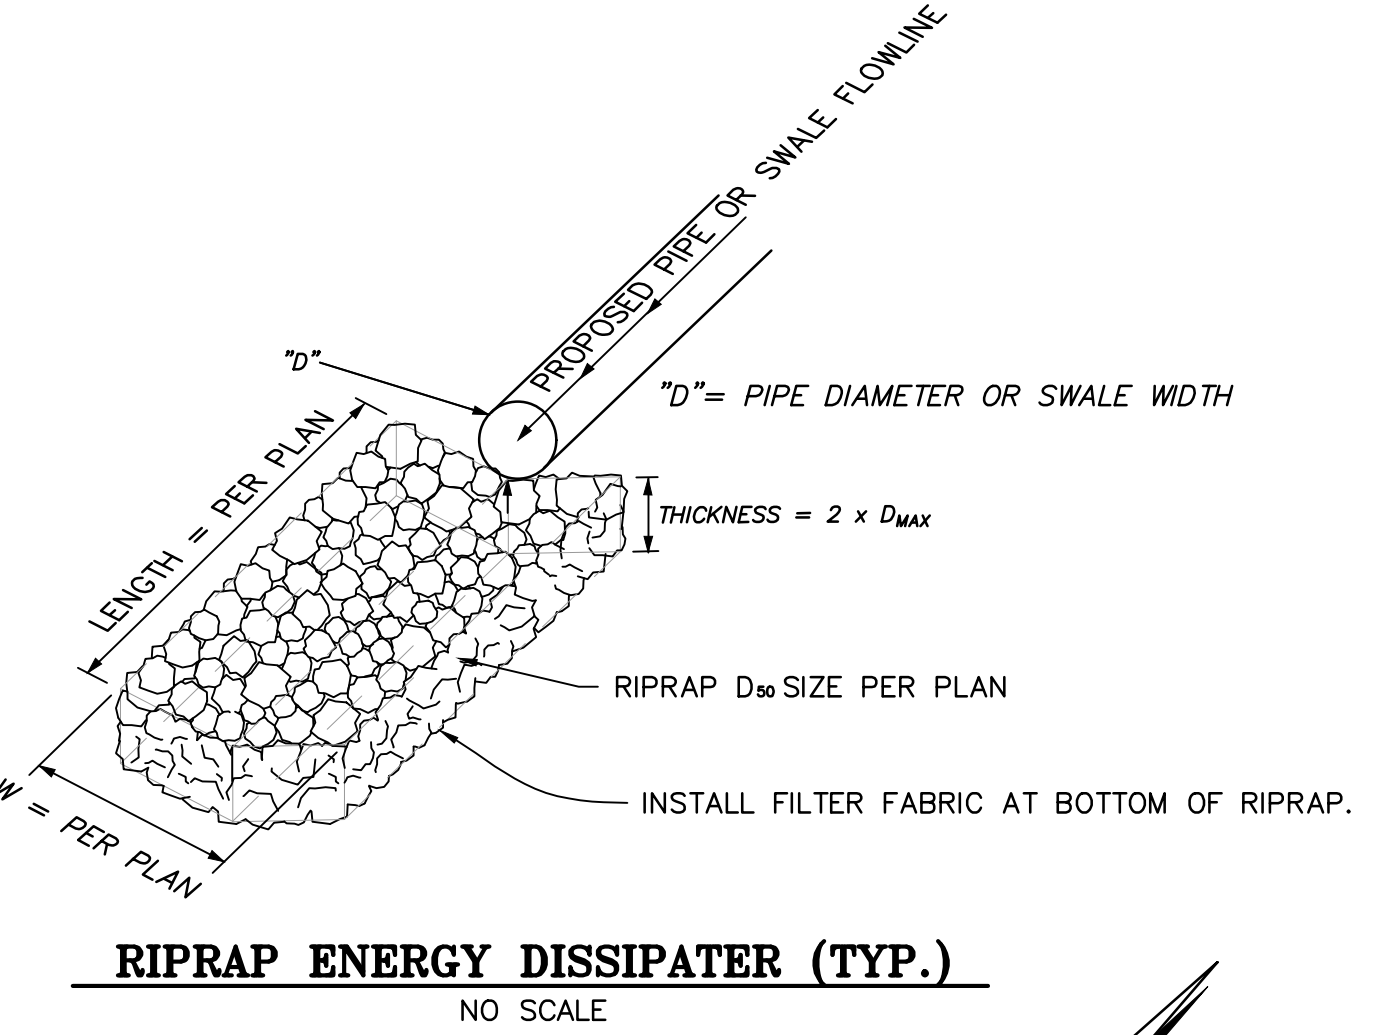

APN 949-220-031/032
COMMUNITY COMMERCIAL ZONE
COMMERCIAL LAND USE

APN:
949-220-013
949-220-014



<p>"AS BUILT" THE RECEIPT OF AS - BUILT PLANS AND CITY'S ACCEPTANCE THEREOF DOES NOT ABSOLVE THE ENGINEER OF WORK OF ANY RESPONSIBILITY FOR THE PROJECT DESIGN.</p> <p>ENGINEER OF WORK: _____ DATE: _____ RCE NO. 87481</p>	<p>BASIS OF BEARINGS CENTERLINE OF LOS ALAMOS ROAD BEING N47°47'54"E.</p>	<p>RECOMMEND APPROVAL</p> <p>_____ DATE: _____</p> <p>WILLIAM G. BIXBY BUREAU VERITAS NORTH AMERICA, INC. R.C.E. NO. 48819</p>
---	--	---

REGISTERED PROFESSIONAL ENGINEER
ALEXANDER R. PAULSEN
No. 87481
CIVIL
STATE OF CALIFORNIA

TE SURVEY & ENGINEERING, INC.
4144 ELM STREET, SUITE G
MURRIETA, CA 95562
T: (951) 698-1830
F: (951) 698-1830
E: INFO@TESE-SURVEYANDENGINEERING.COM

DESIGNED BY ARP	DRAWN BY ARP	CHECKED BY JBR
--------------------	-----------------	-------------------




PLANS PREPARED UNDER SUPERVISION OF:

DATE: _____

ALEX R. PAULSEN
RCE NO. 87481

DATE	INITIAL	REVISION DESCRIPTION	SHT. NO.	DATE	INITIAL
ENGR OF WORK	CITY APPROVAL				

SHEET 2	CITY OF MURRIETA ENGINEERING DEPARTMENT	SHEETS 3
PRELIMINARY GRADING PLAN		
APN 949-220-013/014 41450 LOS ALAMOS ROAD, MURRIETA RIVERSIDE COUNTY, CALIFORNIA		
APPROVED ROBERT K. MOEHLING CITY ENGINEER RCE NO. 63056		
DATE: _____		
DWN BY: ARP	PROJECT NO.	DRAWING NO.
CHKD BY: JBR		
FIELD BK:		

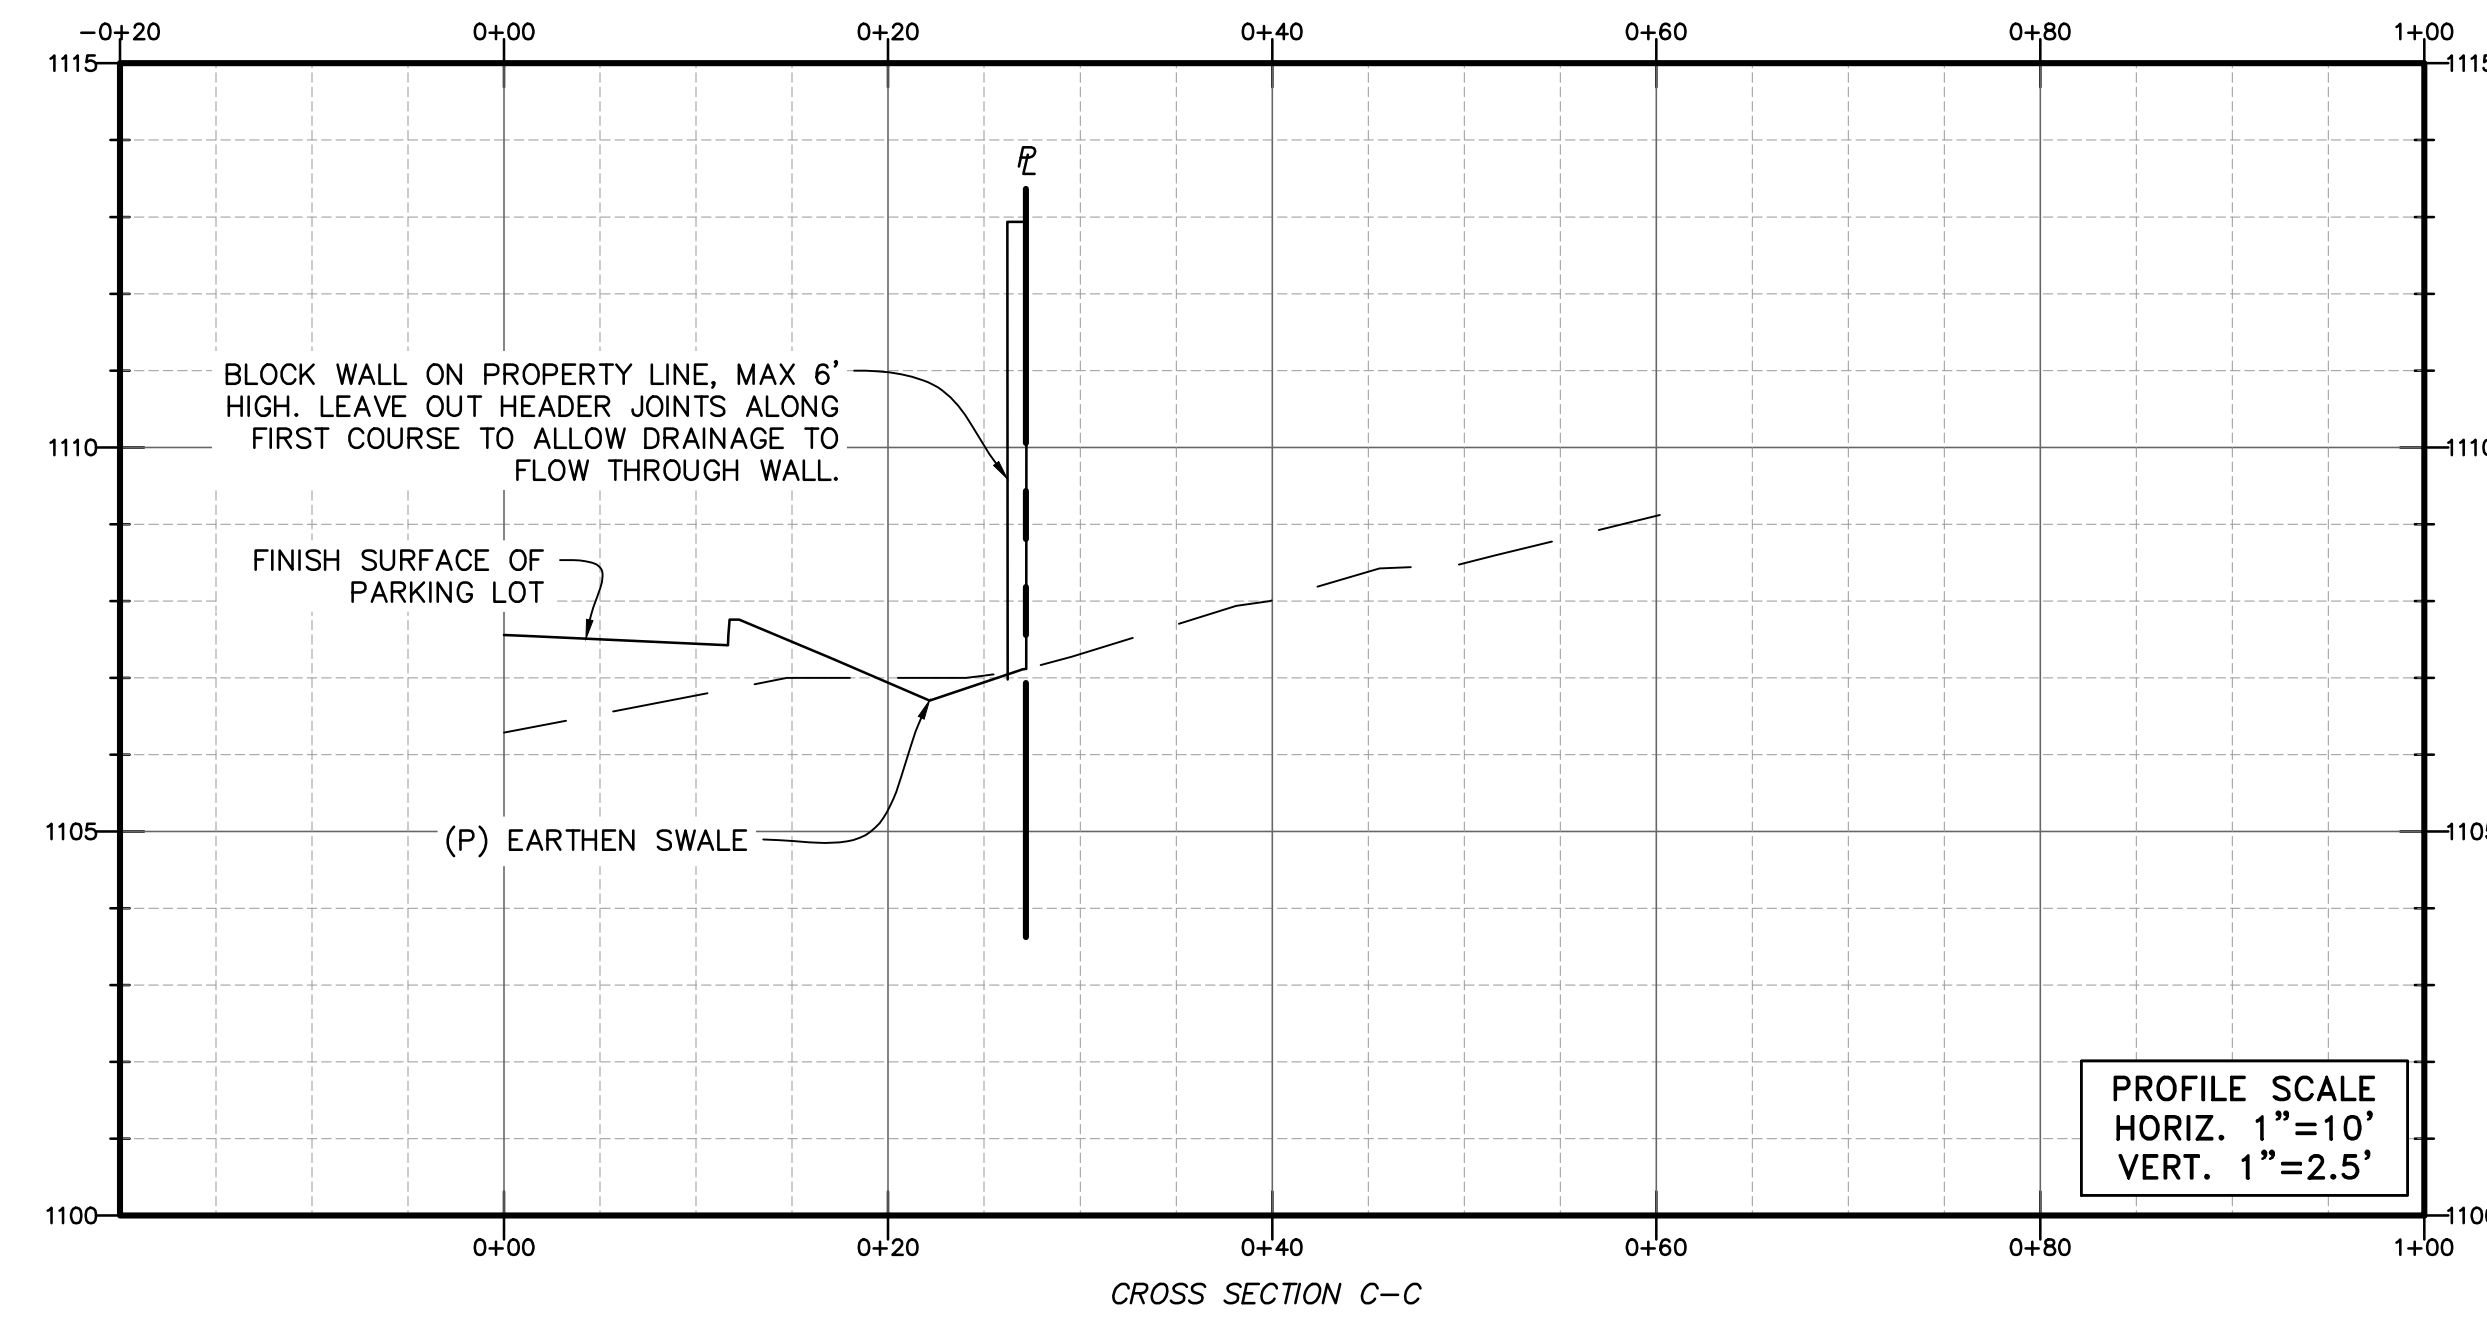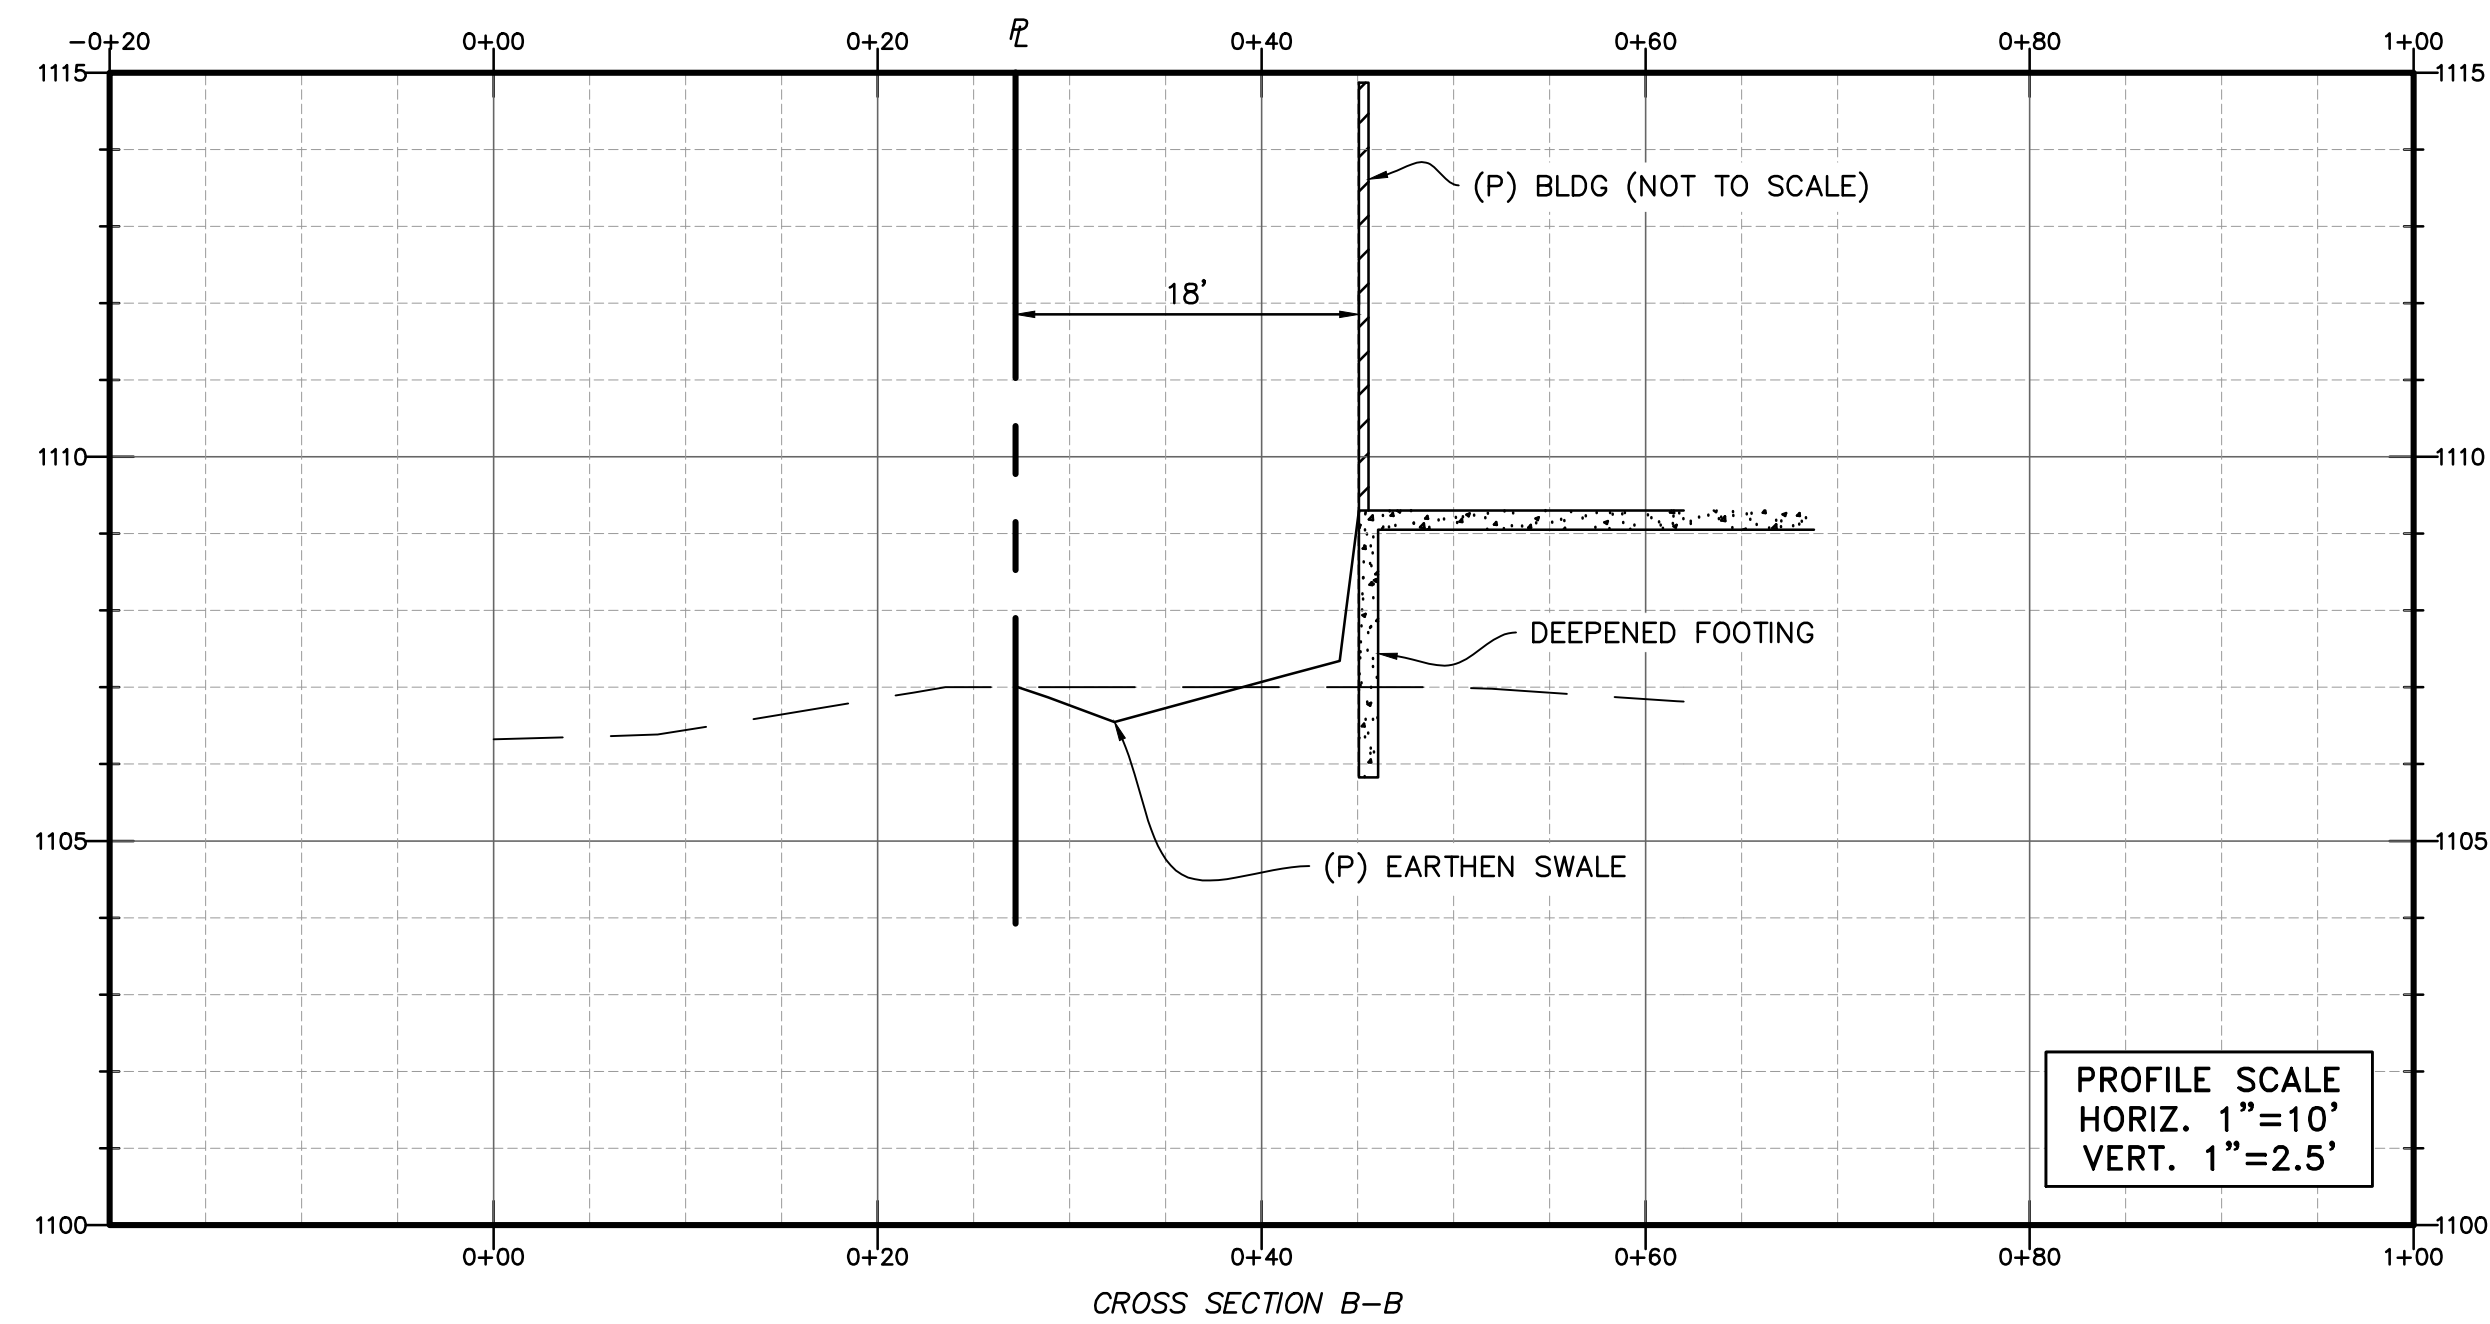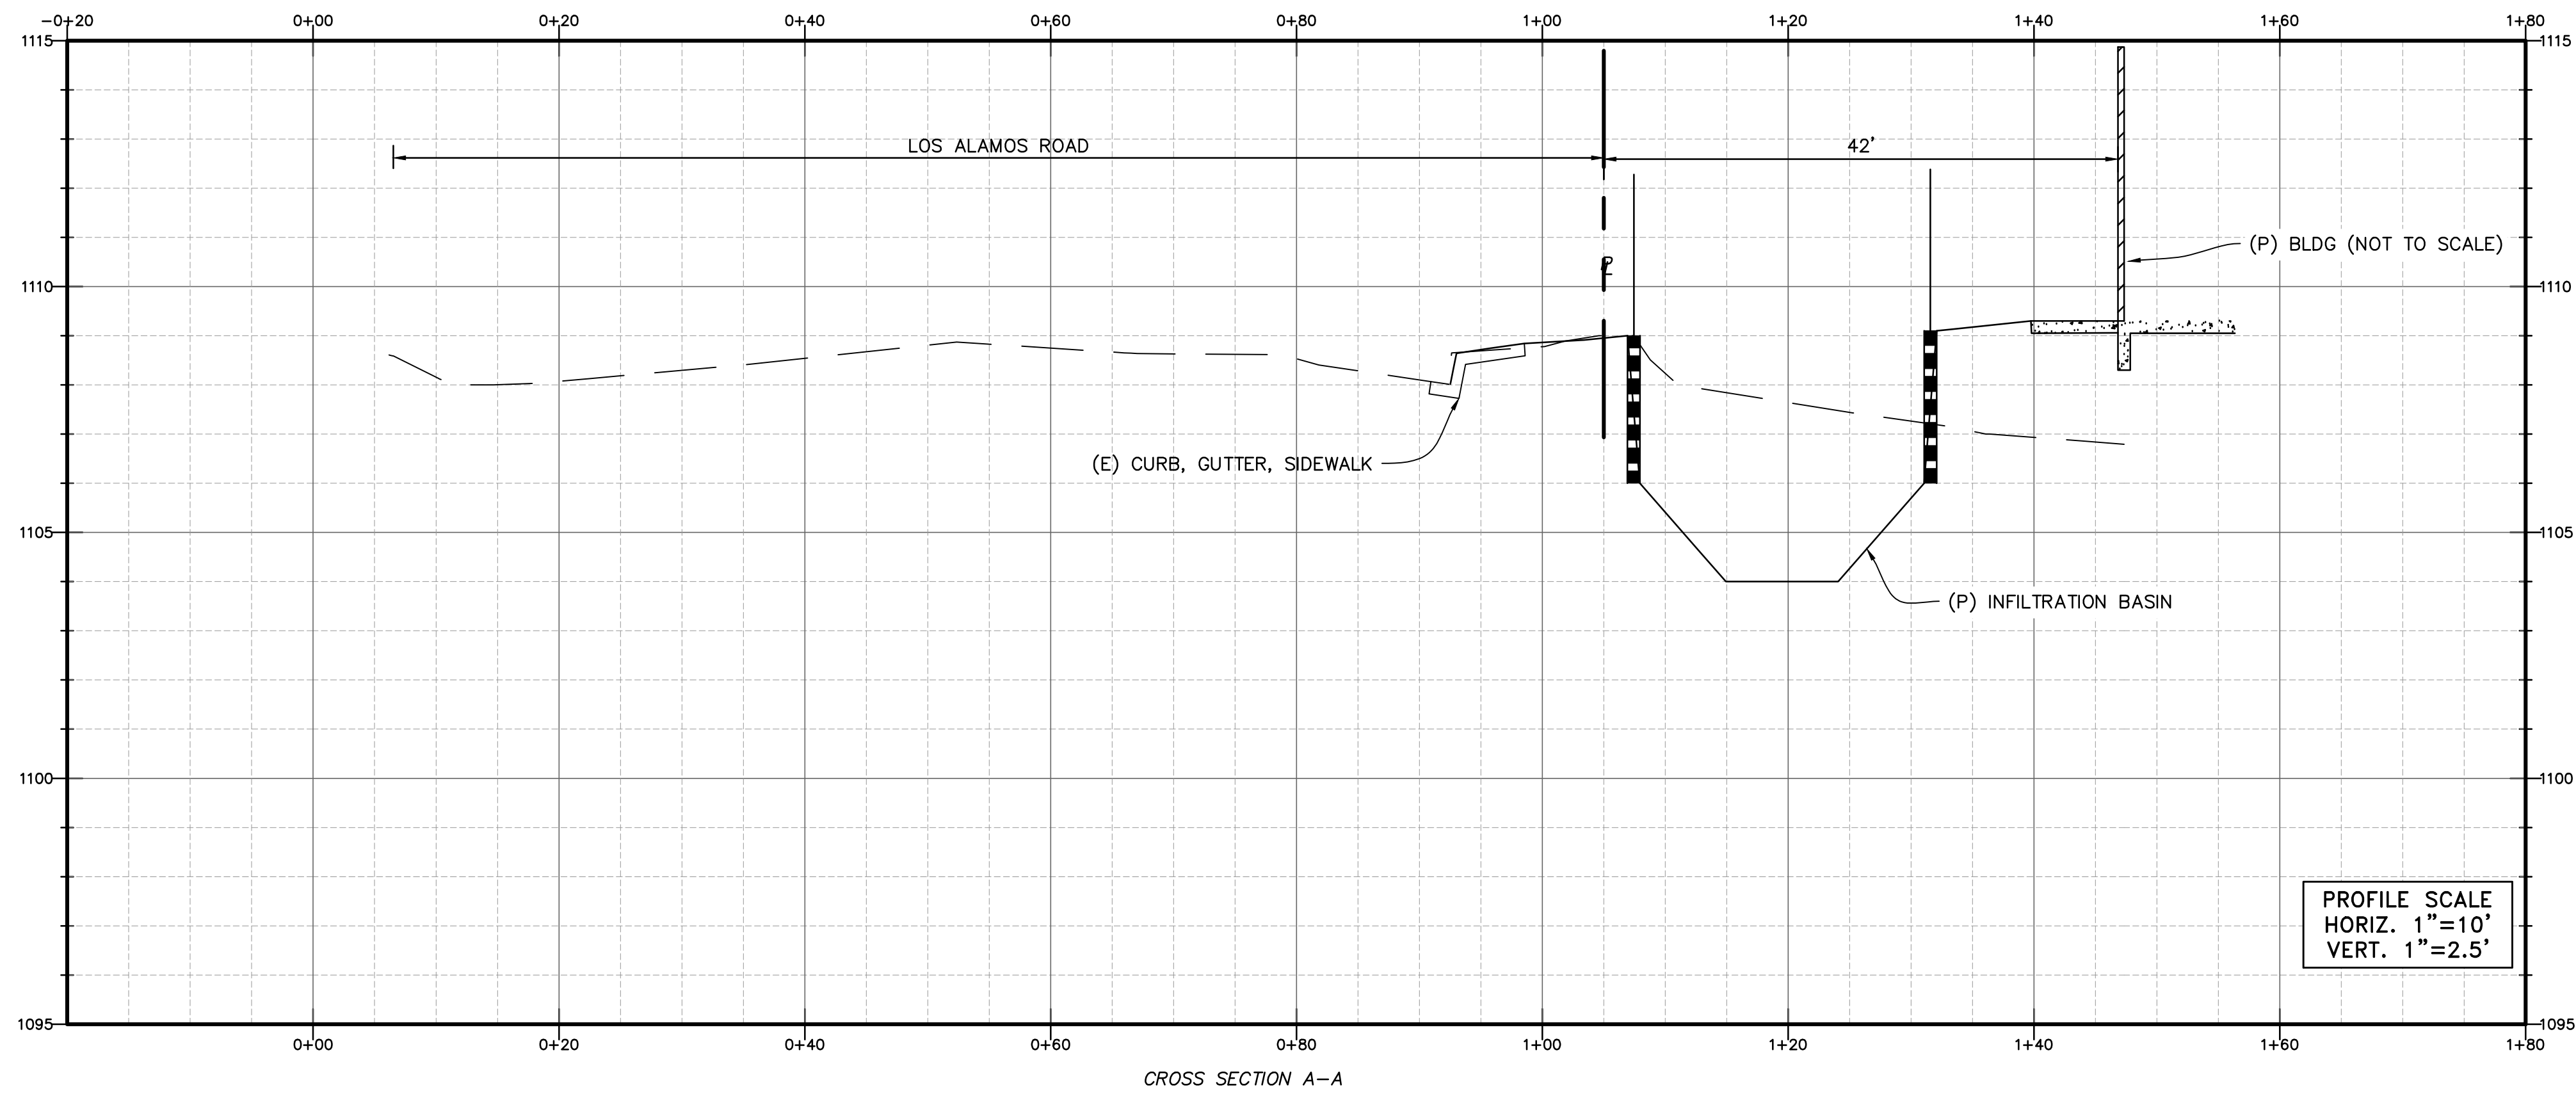

A.P.N.:
949-220-013
949-220-014




Know what's below.
Call before you dig.

"AS BUILT"
THE RECEIPT OF AS - BUILT PLANS AND CITY'S ACCEPTANCE THEREOF DOES NOT ABSOLVE THE ENGINEER OF WORK OF ANY RESPONSIBILITY FOR THE PROJECT DESIGN.
ENGINEER OF WORK: _____ DATE: _____
R.C.E. NO. 87481

BASIS OF BEARINGS
CENTERLINE OF LOS ALAMOS ROAD BEING N47°47'54"E.

RECOMMEND APPROVAL

DATE: _____
WILLIAM G. BIXBY
BUREAU VERITAS NORTH AMERICA, INC.
R.C.E. NO. 48819

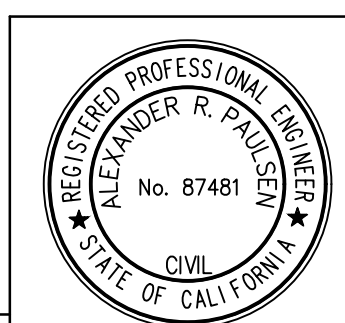

TE SURVEY & ENGINEERING, INC.
4146 ELM STREET, SUITE G
MURRIETA, CA 95562
T: (951) 698-1830
E: INFO@TE-SURVEYANDENG.COM


DESIGNED BY: ARP
DRAWN BY: ARP
CHECKED BY: JBR

PLANS PREPARED UNDER SUPERVISION OF: _____
DATE: _____
ALEX R. PAULSEN
RCE NO. 87481

DATE	INITIAL	REVISION DESCRIPTION	SHT. NO.	DATE	INITIAL

SHEET 3	CITY OF MURRIETA ENGINEERING DEPARTMENT	SHEETS 3
CROSS SECTIONS		
APN 949-220-013/014 41450 LOS ALAMOS ROAD, MURRIETA RIVERSIDE COUNTY, CALIFORNIA		
APPROVED ROBERT K. MOEHLING _____ DATE: _____ CITY ENGINEER RCE NO. 63056		
DWN BY: ARP	PROJECT NO.	DRAWING NO.
CHKD BY: JBR		
FIELD BK: _____		

Plotted By: Zootaroh, Basel
 Sheet Set: Kna_Layout: Option 2, March 30, 2023 04:28:18pm
 K:\ORA_LDEV\U-Haul\XXXXXXXXXX - Murrieta (Jefferson)\CAD\Exhibits\Fire Access Exhibit.dwg
 This document, together with the concepts and design presented herein, is intended only for the specific purpose and client for which it was prepared. Reuse of and improper reliance on this document without written authorization and adaptation by Kimley-Horn and Associates, Inc. shall be without liability to Kimley-Horn and Associates, Inc.

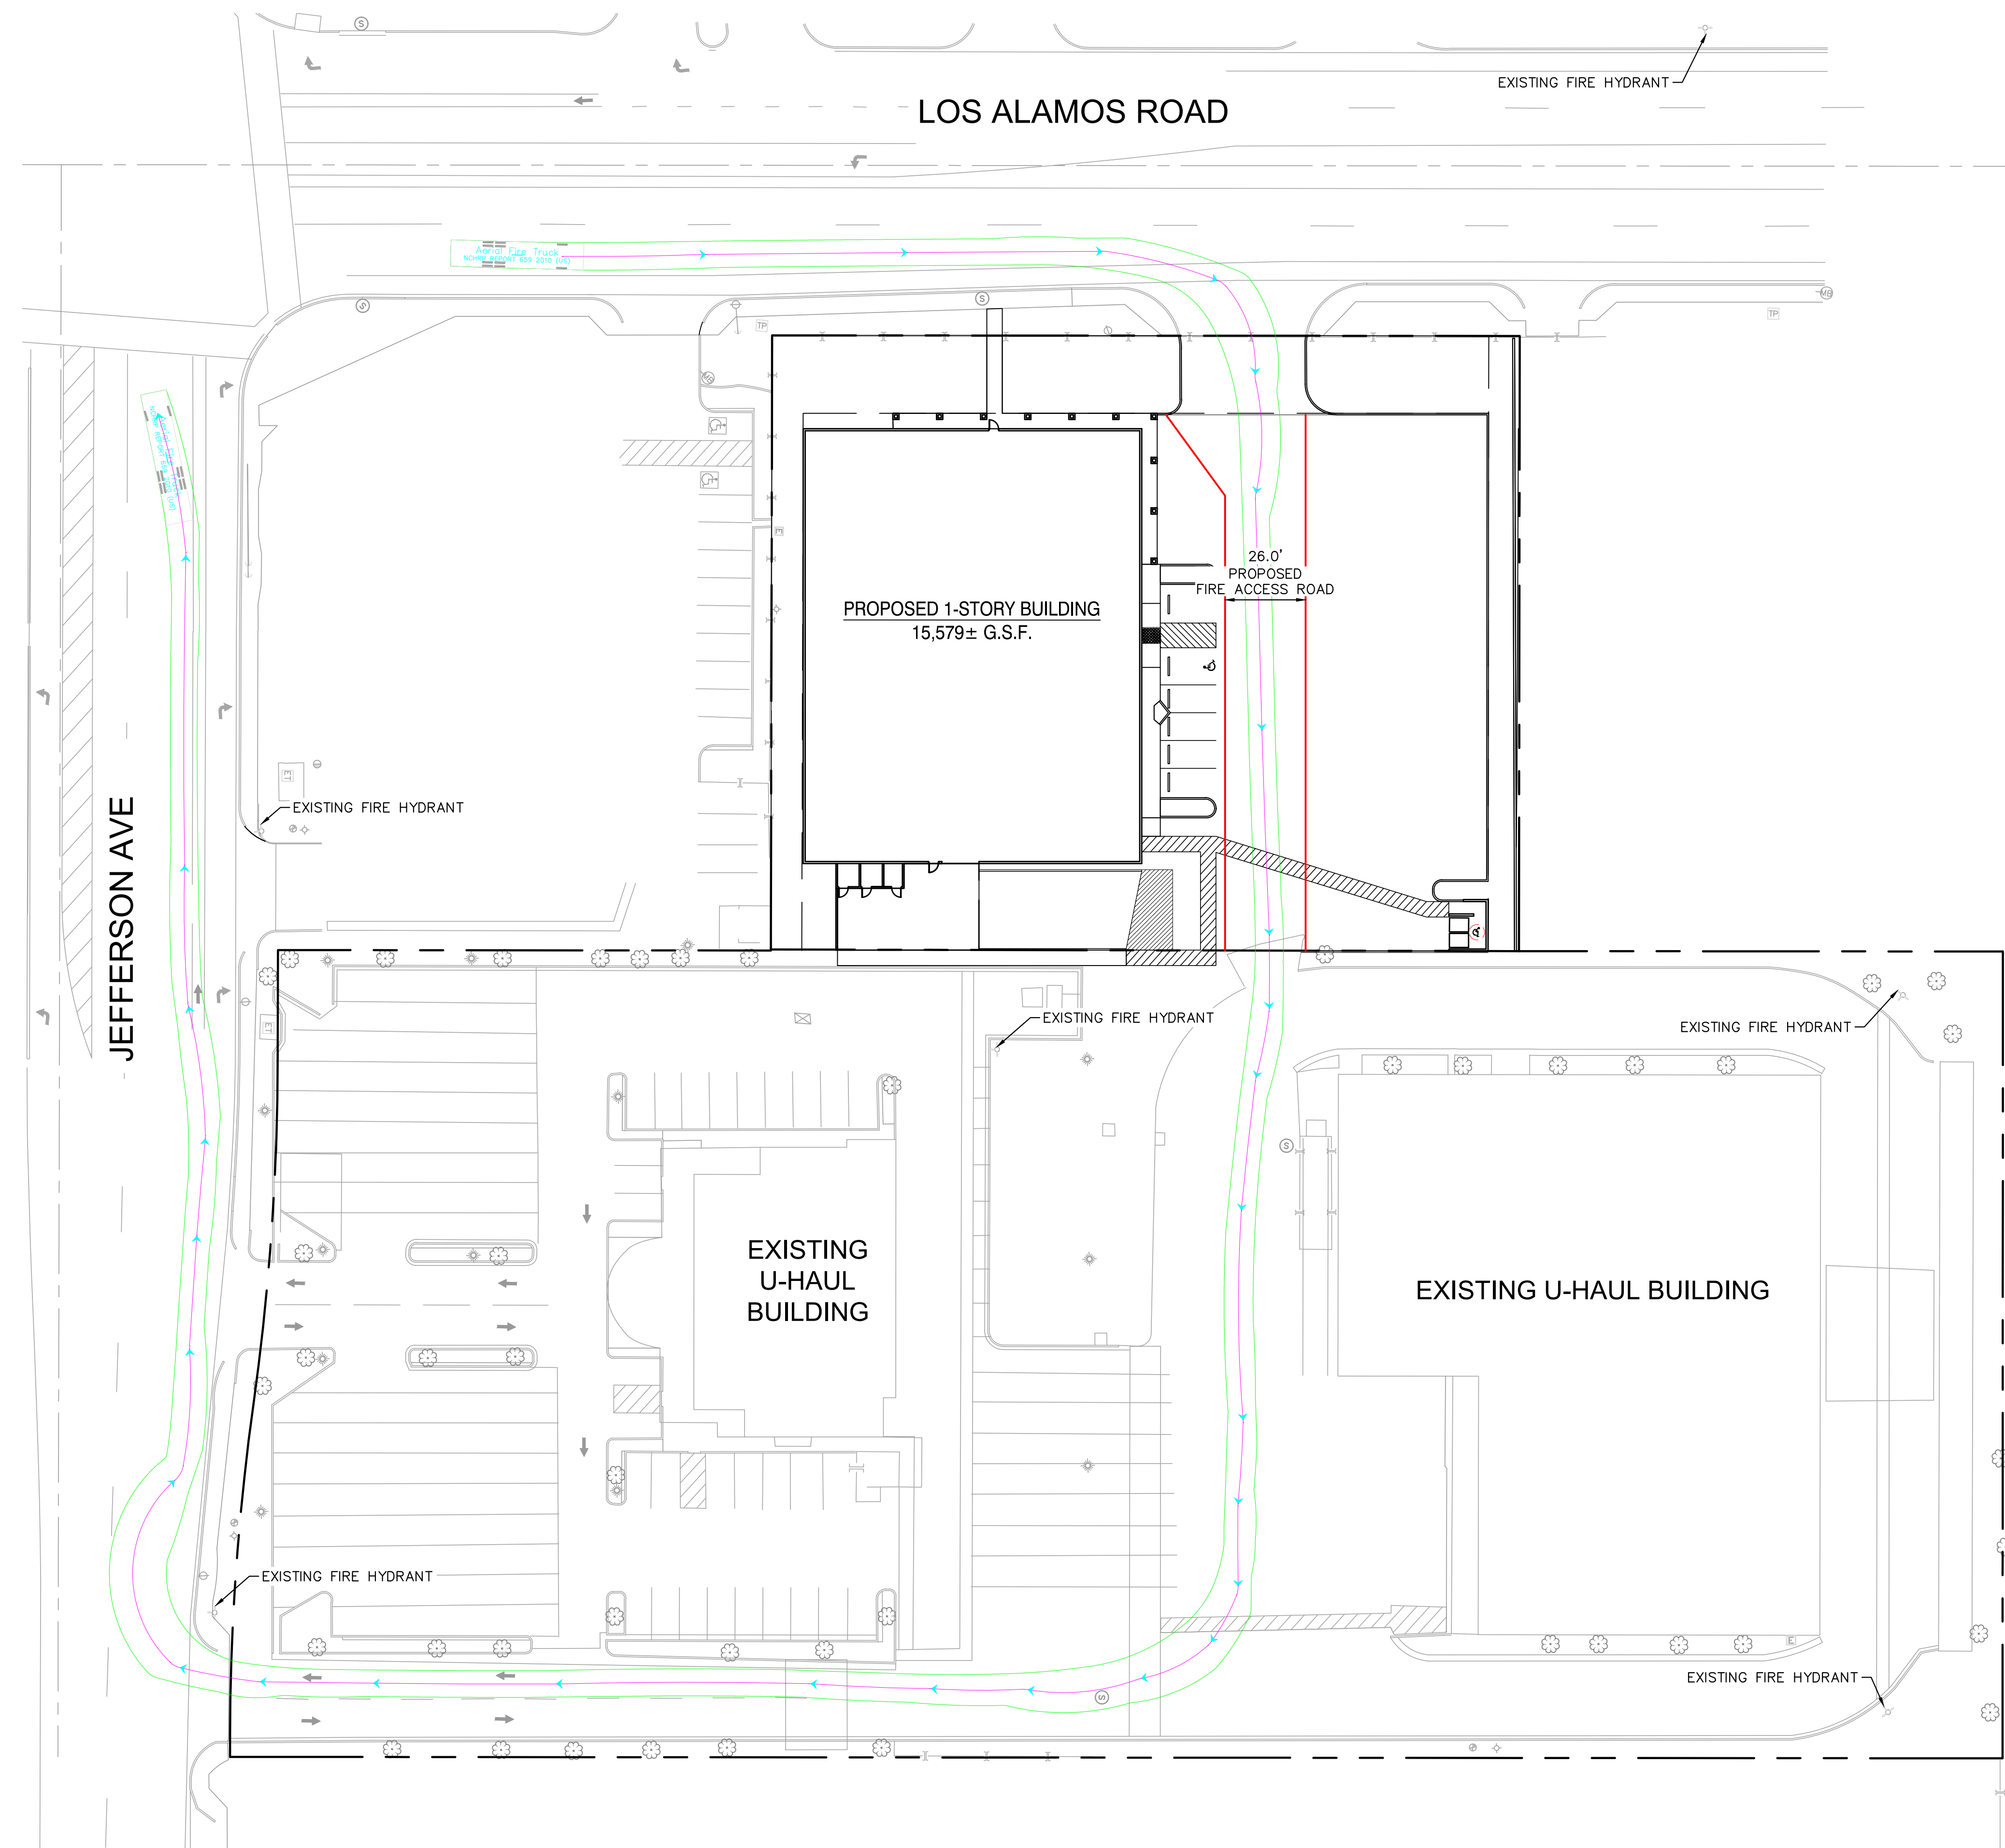


SITE ADDRESS
 25086 JEFFERSON AVE, MURRIETA CA 92562

LEGEND


— — — — — STREET CENTERLINE
 - - - - - PROPERTY LINE

PLAN NOTES

1. THIS PLAN IS PRELIMINARY IN NATURE AND SHOULD NOT BE USED FOR ZONING ANALYSIS. PREPARATION OF A SITE SURVEY AND ADDITIONAL EVALUATION WILL BE REQUIRED TO DETERMINE THE FEASIBILITY OF THE PROPOSED TRUCK MOVEMENT AND TO REVIEW ZONING REQUIREMENTS.
2. FURTHER COORDINATION WITH VENDORS IS REQUIRED AND LOCATION OF PROGRAMMATIC SITE ITEMS ARE PRELIMINARY IN NATURE.

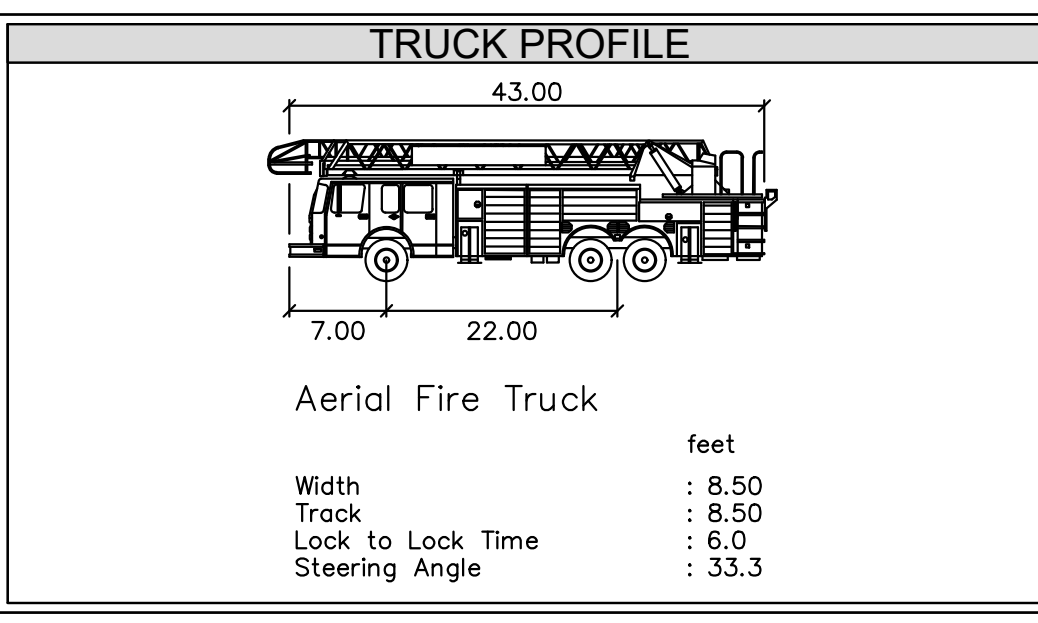

FIRE DEPARTMENT APPROVAL AND NOTES

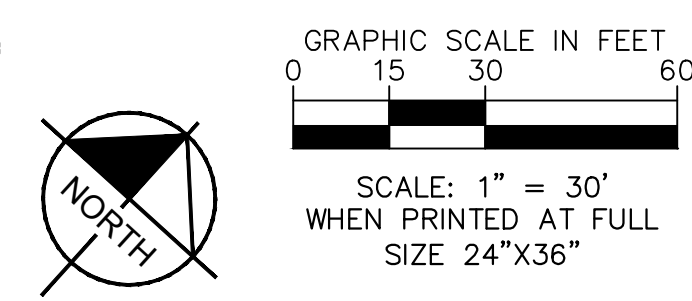

No.	REVISIONS	DATE	BY

Kimley»Horn

© 2023 KIMLEY-HORN AND ASSOCIATES, INC.
 1100 W TOWN AND COUNTRY ROAD, SUITE 700, ORANGE, CA 92868
 PHONE: 714-939-1030 FAX: 714-938-9488
 WWW.KIMLEY-HORN.COM

KH PROJECT
 1943330
 DATE
 3/10/2023
 SCALE AS SHOWN
 DESIGNED BY BAZ
 DRAWN BY BAZ
 CHECKED BY TDK

U-HAUL AMERCO REAL ESTATE COMPANY

U-HAUL OF MURRIETA
 25086 JEFFERSON AVE, MURRIETA, CA 92562



FIRE ACCESS PLAN

SHEET NUMBER
1

Development Services
 Department
 Planning Division
 Received on: 08/09/2024
 Case #:

CONCEPTUAL LANDSCAPE PLAN

FOR
U-HAUL MOVING & STORAGE

U-HAUL OF MURRIETA
MURRIETA, CA. 92562

AMERCO REAL ESTATE / U-HAUL

2727 N. CENTRAL AVE. 9-N PHOENIX, AZ. 85004

PHONE: (951)588-5776

CONTACT: JASON MASTRIANA

SHEET INDEX		
Sheet Description	Sheet Number	Sheet Title
LT-1	1	TITLE SHEET
LI-1	2	NEW IRRIGATION PLAN
LI-2	3	EXISTING IRRIGATION PLAN
LI-3	4	EXISTING IRRIGATION PLAN
LID-1	5	IRRIGATION DETAILS
LIS-1	6	IRRIGATION SPECIFICATIONS
LP-1	7	NEW PLANTING PLAN
LP-2	8	EXISTING PLANTING ADDITIONS
LP-3	9	EXISTING PLANTING ADDITIONS
LPD-1	10	PLANTING DETAILS
LPS-1	11	PLANTING SPECIFICATIONS

IRRIGATION NOTES:

- The contractor shall notify the Landscape Architect and the City Inspectors a minimum of 48 hours prior to starting construction.
- The design is diagrammatic only. All piping, valves, backflow preventors, wiring, etc. shown within paved areas are for design clarification only, and shall be installed in planter areas where ever possible.
- Do not willfully install the irrigation system as shown on these drawings when it is obvious in the field that obstructions, grade differences or differences in area dimensions exist that might not have been considered in the engineering. Such obstructions or differences shall be brought to the attention of the City's authorized representative. In the event this notification is not performed in writing, the contractor shall assume full responsibility for any revisions necessary.
- It is the responsibility of the contractor to familiarize themselves with all grade differences, locations of fixtures, utilities, signs, posts, poles, walls and paving. The contractor shall repair or replace all items damaged by their work. They shall coordinate their work with other contractors (if any) for the location and installation of pipe sleeves and laterals through walls, under roadways and under paving, etc.
- All irrigation equipment shall be installed as per manufacturer's recommendations and specifications. Refer to specifications for additional information.
- All lateral, mainline piping and control wires under paving shall be installed in separate sleeves. Mainline sleeve size shall be a minimum of twice (2x) the outside diameter of the pipe to be sleeved. Control wire sleeves shall be of sufficient size for the required number of wires under paving. Refer to plan.
- All sleeves under roadways shall be schedule 80 (new). Existing sleeves shall remain in place, if extensions are required the pipe shall be sch. 80. Lateral line sleeves under paving shall be schedule 40. All sleeves shall be P.V.C. or as noted on plans.
- Pipe sizes shall conform to those shown on the plans and details. No substitutions of smaller pipe sizes shall be permitted, but substitutions of larger sizes may be approved. All damaged and rejected pipe shall be removed from the site at the time of said rejection.
- The contractor shall make the final connection from the electrical source to the controller.
- The irrigation system shall be fully automatic. Control valves shall be installed per details.
- All proposed landscape areas are to be converted to drip irrigation, removing and replacing all existing irrigation components as needed to insure the system runs per manufacturer specifications.
- Mainline, valves, irrigation meters, etc., are shown on the street and/or sidewalk for clarification only. Install in planter area throughout the site.
- Adjust all sprinklers for 100% coverage.
- After establishment of all plant material, controllers shall be pro-programmed to irrigate solely during early morning.
- The contractor shall adjust the schedule to meet site specific requirements and use the baseline schedule to set the weather based controller. The schedule currently in effect shall be posted in the controller.
- No low head drainage allowed.
- The controller shall be operational and set to real-time weather prior to the completion of the 90-day maintenance period of the installing contractor.

PLANTING NOTES:

- GENERAL PLANTING NOTES
- The contractor must notify the Landscape Architect, (951) 737-1124, 48 hours prior to starting construction.
 - The contractor shall be responsible for obtaining building permits prior to commencing construction.
 - The contractor shall notify the architect if discrepancies exist between existing site conditions and plans.
 - All construction shall meet or exceed City standards and guidelines.
 - The design shown is diagrammatic, the contractor shall review the site conditions prior to bidding.
 - Protect all existing trees and shrubs in place. Existing shrubs shall be trimmed, as directed by the City Landscape Architect, into natural shapes only. No gas powered hedge tools to be used on any shrub. Shrubs shall only be trimmed after the blooming season is over.
 - Existing trees will require proper trimming by an ISA (International Society of Arboriculture) Certified Arborist (on staff) tree trimming company.
 - Infill bare areas with shrubs as shown. Additional shrubs and trees may be required as directed by the City Landscape Architect, if any are considered to be in substandard condition.
 - Shrubs are kept a minimum of three feet from the doors of the electrical unit or as specified by the utility agency.
 - A minimum of 3" layer of bark mulch shall be installed in all shrub areas including existing landscape except where cobble is to be installed.
 - All trees and shrubs shall be placed a minimum of 5' from water meter, gas meter, or sewer laterals; a minimum of 10' away from utility poles; and a minimum of 8' away from fire hydrants and fire department sprinkler and standpipe connections.

SOILS NOTES

- All soil next to curbs and sidewalks shall be graded at one inch to two inches below the finished surface.
- A post grading agronomic soils analysis is required. Contractor shall amend the soil in accordance with the recommendations of the report.
- Soil amendments shall be added to all planting areas with gradients 2:1 and less in accordance with post grading soil analysis recommendations.

ROOT BARRIER NOTES

- Root panels and linear barriers are required for all trees planted within a parkway or within 8-foot of any walking or drivable surface in accordance with the Landscape and Irrigation Standards Plans and Specifications.

SITE DESCRIPTION


Parcel 3 - APN - 949-220-013-6 20,895 sf / 0.48 acres
Parcel 4 - APN - 949-220-014-7 27,333 sf / 0.63 acres

Total Gross Area/ Acreage 48,128 sf / 1.11 acres
Total Net Area/ Acreage 48,128 sf / 1.11 acres
Overall Dimensions 199.00' x 241.75'


Zone: CC - Community Commercial
Overlay: Tod Overlay

Adjacent Zoning:
N: CC - Community Commercial
E: CC - Community Commercial
S: MF-3 - Residential
W: MF-3 / CC - Residential / Community Commercial

VICINITY MAP

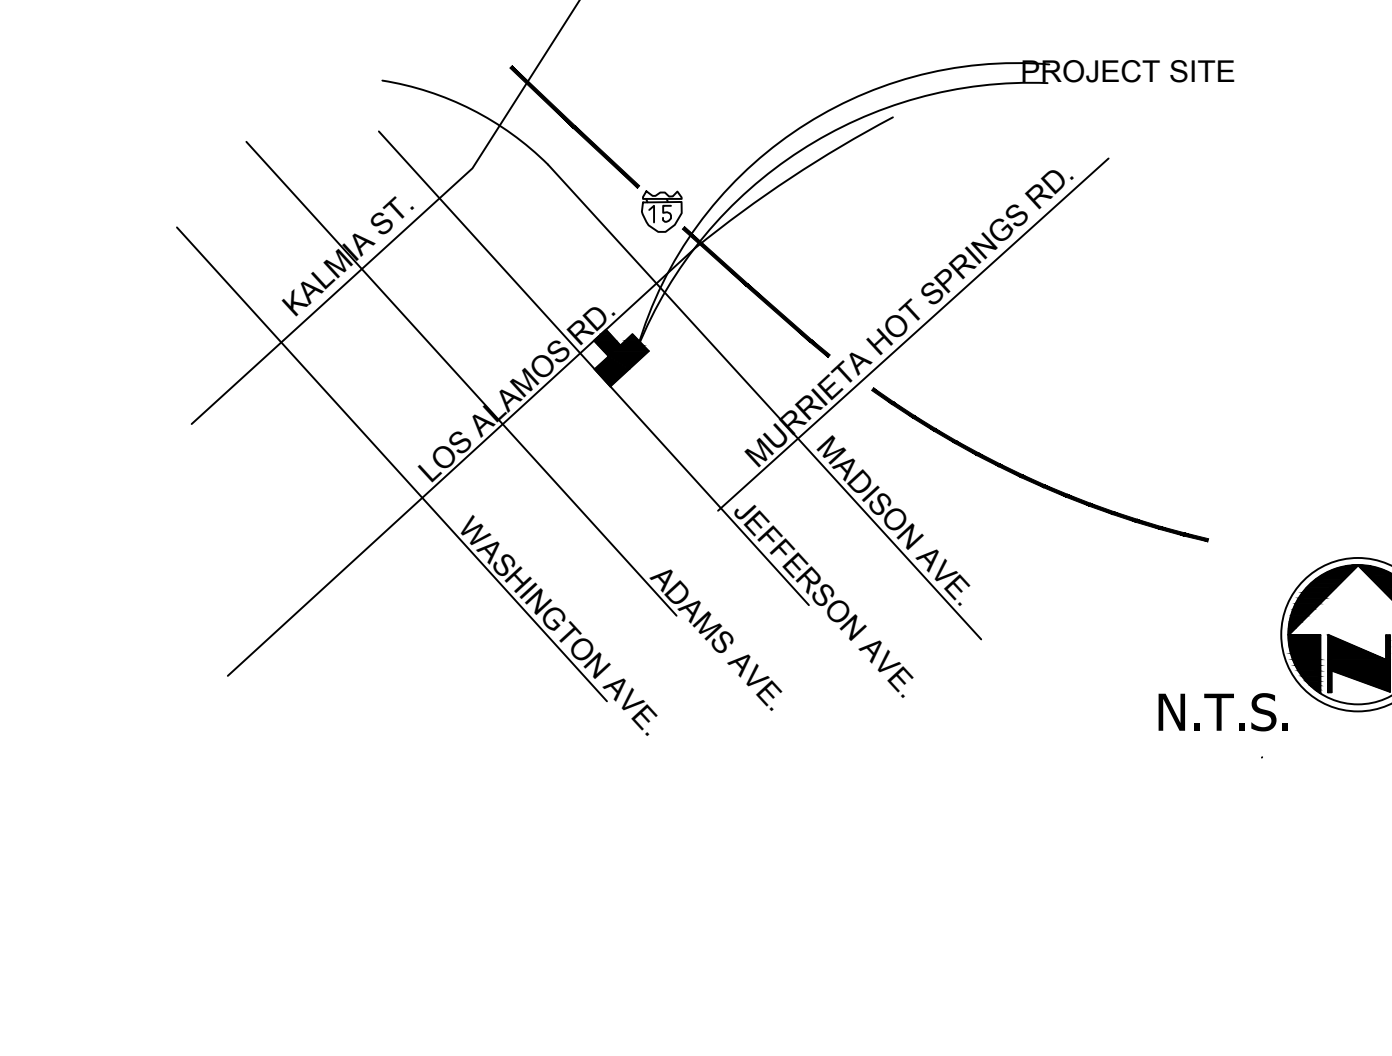

INDEX MAP

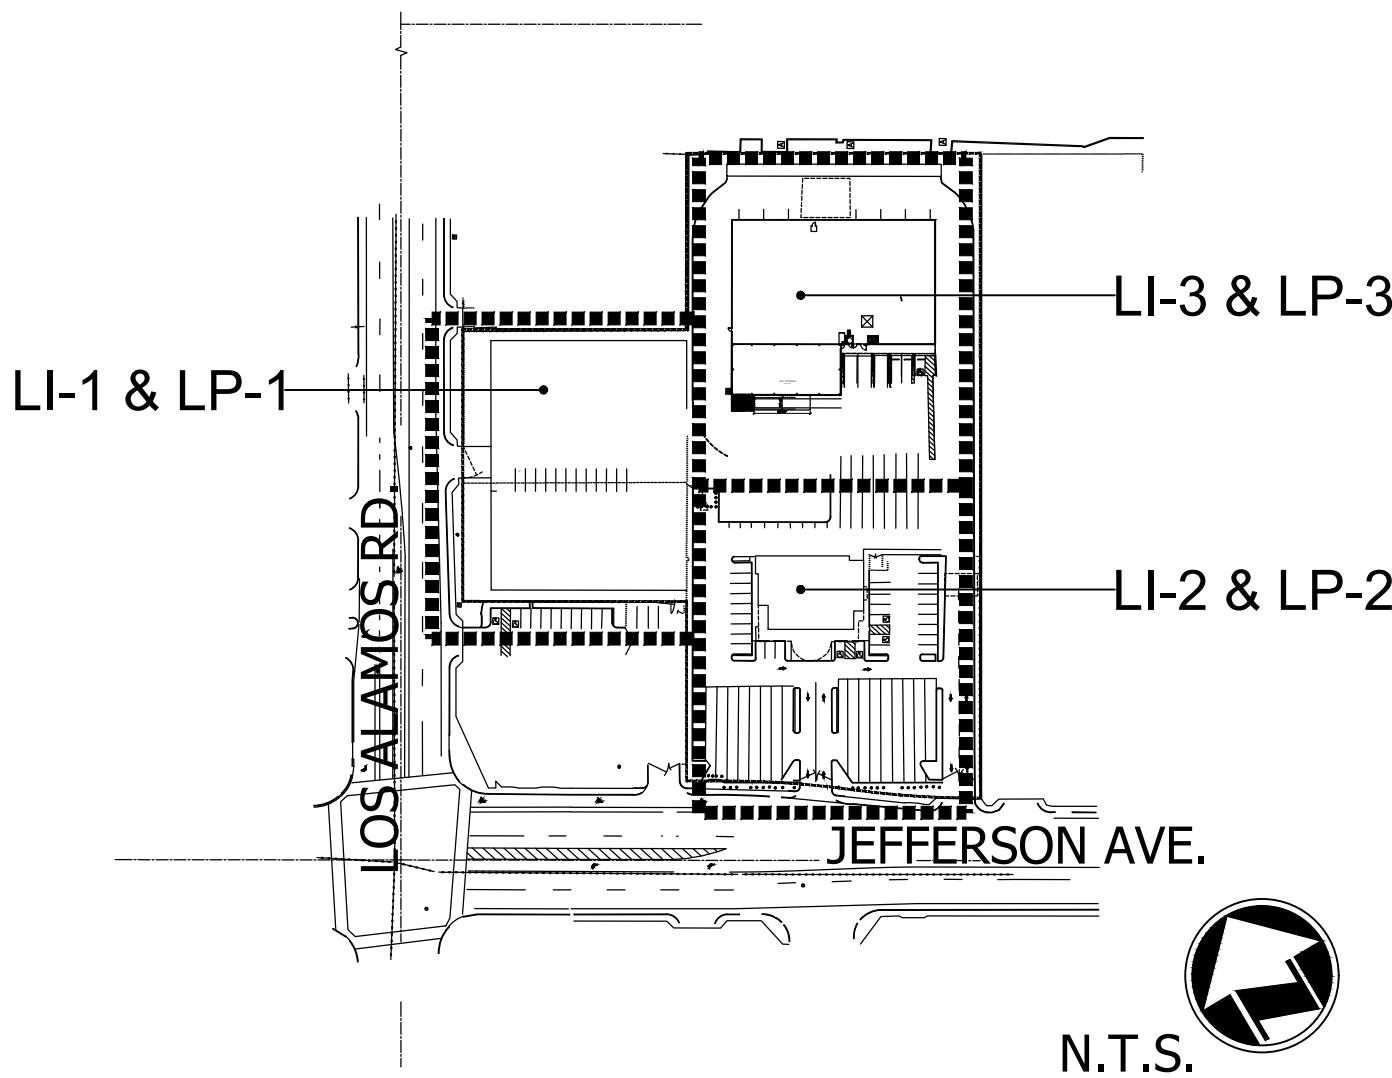

ABBREVIATIONS:

AD AREA DRAIN	FG FINISH GRADE	REF REFERENCE
ADJ ADJUSTABLE	FIN FINISH	REINF REINFORCED
AGGR AGGREGATE	FL FLOOR	REQ REQUIRED
APPROX APPROXIMATELY	FOW FACE OF WALL	ROW RIGHT OF WAY
ARCH ARCHITECTURAL	FS FINISH SURFACE	RP REFERENCE POINT
ASPH ASPHALT	FSG FINISHED SUB-GRADE	RWD REDWOOD
BF BOTTOM OF FENCE	FT FOOT OR FEET	S SOUTH
BLDG BUILDING	FTG FOOTING	SCHED SCHEDULE
BLK BLOCK	GB GRADE BREAK	SECT SECTION
BM BENCHMARK	GND GROUND	SF SQUARE FOOT OR FEET
BOT BOTTOM	HB HOSE BIBB	SHT SHEET
BP BOTTOM OF PILASTER	HGT HEIGHT	SPEC SPECIFICATION
BW BOTTOM OF WALL	HORIZ HORIZONTAL	SQ SQUARE
CB CATCH BASIN	ID INSIDE DIAMETER	SST STAINLESS STEEL
CL CENTERLINE	JT JOINT	STA STATION
CLKG CAULKING	LF LINEAR FOOT OR FEET	STD STANDARD
CLR CLEAR	MAX MAXIMUM	STL STEEL
COL COLUMN	MC MECHANICAL	STRL STRUCTURAL
CONC CONCRETE	MEMB MEMBRANE	SYS SYMMETRICAL
CONSTR CONSTRUCTION	MET METAL	TC TOP OF CURB
CONT CONTINUOUS	MFR MANUFACTURER	TF TOP OF FENCE
CTR CENTER	MH MANHOLE	THK THICK
DET DETAIL	MIN MINIMUM	TOC TOP OF CONCRETE
DF DRINKING FOUNTAIN	MISC MISCELLANEOUS	TP TOP OF PAVEMENT
DG DECOMPOSED GRANITE	N NORTH	TR TOP OF RAIL
DIA DIAMETER	NG NATURAL GRADE	TRD TREAD
DIM DIMENSION	NIC NOT IN CONTACT	TW TOP OF WALL
DN DOWN	NO NUMBER	TYP TYPICAL
DR DOOR	NTS NOT TO SCALE	UNF UNFINISHED
DS DOWNSPOUT	OC ON CENTER	UON UNLESS OTHERWISE
DWG DRAWING	OD OUTSIDE DIAMETER	NOTED
E EAST	OP OPENING	VERT VERTICAL
EA EACH	PA PLANTER AREA	W WEST
EJ EXPANSION JOINT	POB POINT OF BEGINNING	W/ WITH
EL ELEVATION	POC POINT OF CONNECTION	WD WOOD
ELEC ELECTRICAL	PRCST PRE-CAST	WI WROUGHT IRON
EQ EQUAL	PT POINT	W/O WITHOUT
EXP EXPANSION	R RISER	WP WATERPROOF
EXPO EXPOSED	RAD RADIUS	WT WEIGHT
EXST EXISTING	RD ROOF DRAIN	

GENERAL NOTES:

ALL AREA OF THE SITE TO BE PRIVATELY MAINTAINED

The landscape plans shall comply with all applicable codes of the Murrieta Municipal Code - Title 16.28

HOLD HARMLESS & INDEMNIFICATION CLAUSE

Contractor agrees that they shall assume sole responsibility for job site conditions during the course of construction of this project, including safety of all persons and property, that this requirement shall apply continuously and not be limited to normal working hours, and hold the county and the landscape architect harmless from any and all liability real or alleged, in connection with the performance of work on this project, excepting for liability arising from the sole negligence of the owner, or the landscape architect.

AFFIDAVIT OF MAINTENANCE RESPONSIBILITY

The development and/or landscape contractor agrees to guarantee and maintain all landscape areas for a minimum of 90 days after completed installation and to guarantee on-site trees for a period no less than six (6) months and street trees for a period of one year. Landscape areas shall be maintained in original condition as approved on the landscape plans even after the Certificate of Occupancy is issued.

PREPARED FOR:



BENCH MARK DESCRIPTION: _____ LOCATION: _____ RECORDED: _____ ELEVATION: _____ DATE: _____

APPROVED FOR SIGNATURE: _____ DATE: _____

PLAN CHECK ENGR. NAME TYPED: _____ DATE: _____

PLAN CHECK FIRM RCE NO.:

"AS BUILT"

THE RECEIPT OF AS-BUILT PLANS AND CITY'S ACCEPTANCE THEREOF DOES NOT ABSOLVE THE ENGINEER OF WORK OF ANY RESPONSIBILITY FOR THE PROJECT DESIGN.


ENGINEER OF WORK: _____ DATE: _____

RCE NO. _____ EXPIRATION DATE: _____

AS NOTED	PREPARED BY	DATE
VERTICAL	STEVE SHIRREL	
AS NOTED	CA LIC NO. 5062	EXP. DATE 12/31/24

DATE	INITIAL	REVISION DESCRIPTION	SHT. NO.	DATE	INITIAL

SHEET 1	CITY OF MURRIETA		SHEETS 11
TITLE SHEET			
U-HAUL OF MURRIETA MURRIETA, CA 92562			
APPROVED _____	DATE _____	DIRECTOR OF PUBLIC WORKS / CITY ENGINEER RCE	
DWN BY: _____	PROJECT NO. _____	DRAWING NO. _____	LT-1
CHKD BY: _____			
FIELD BK: _____			

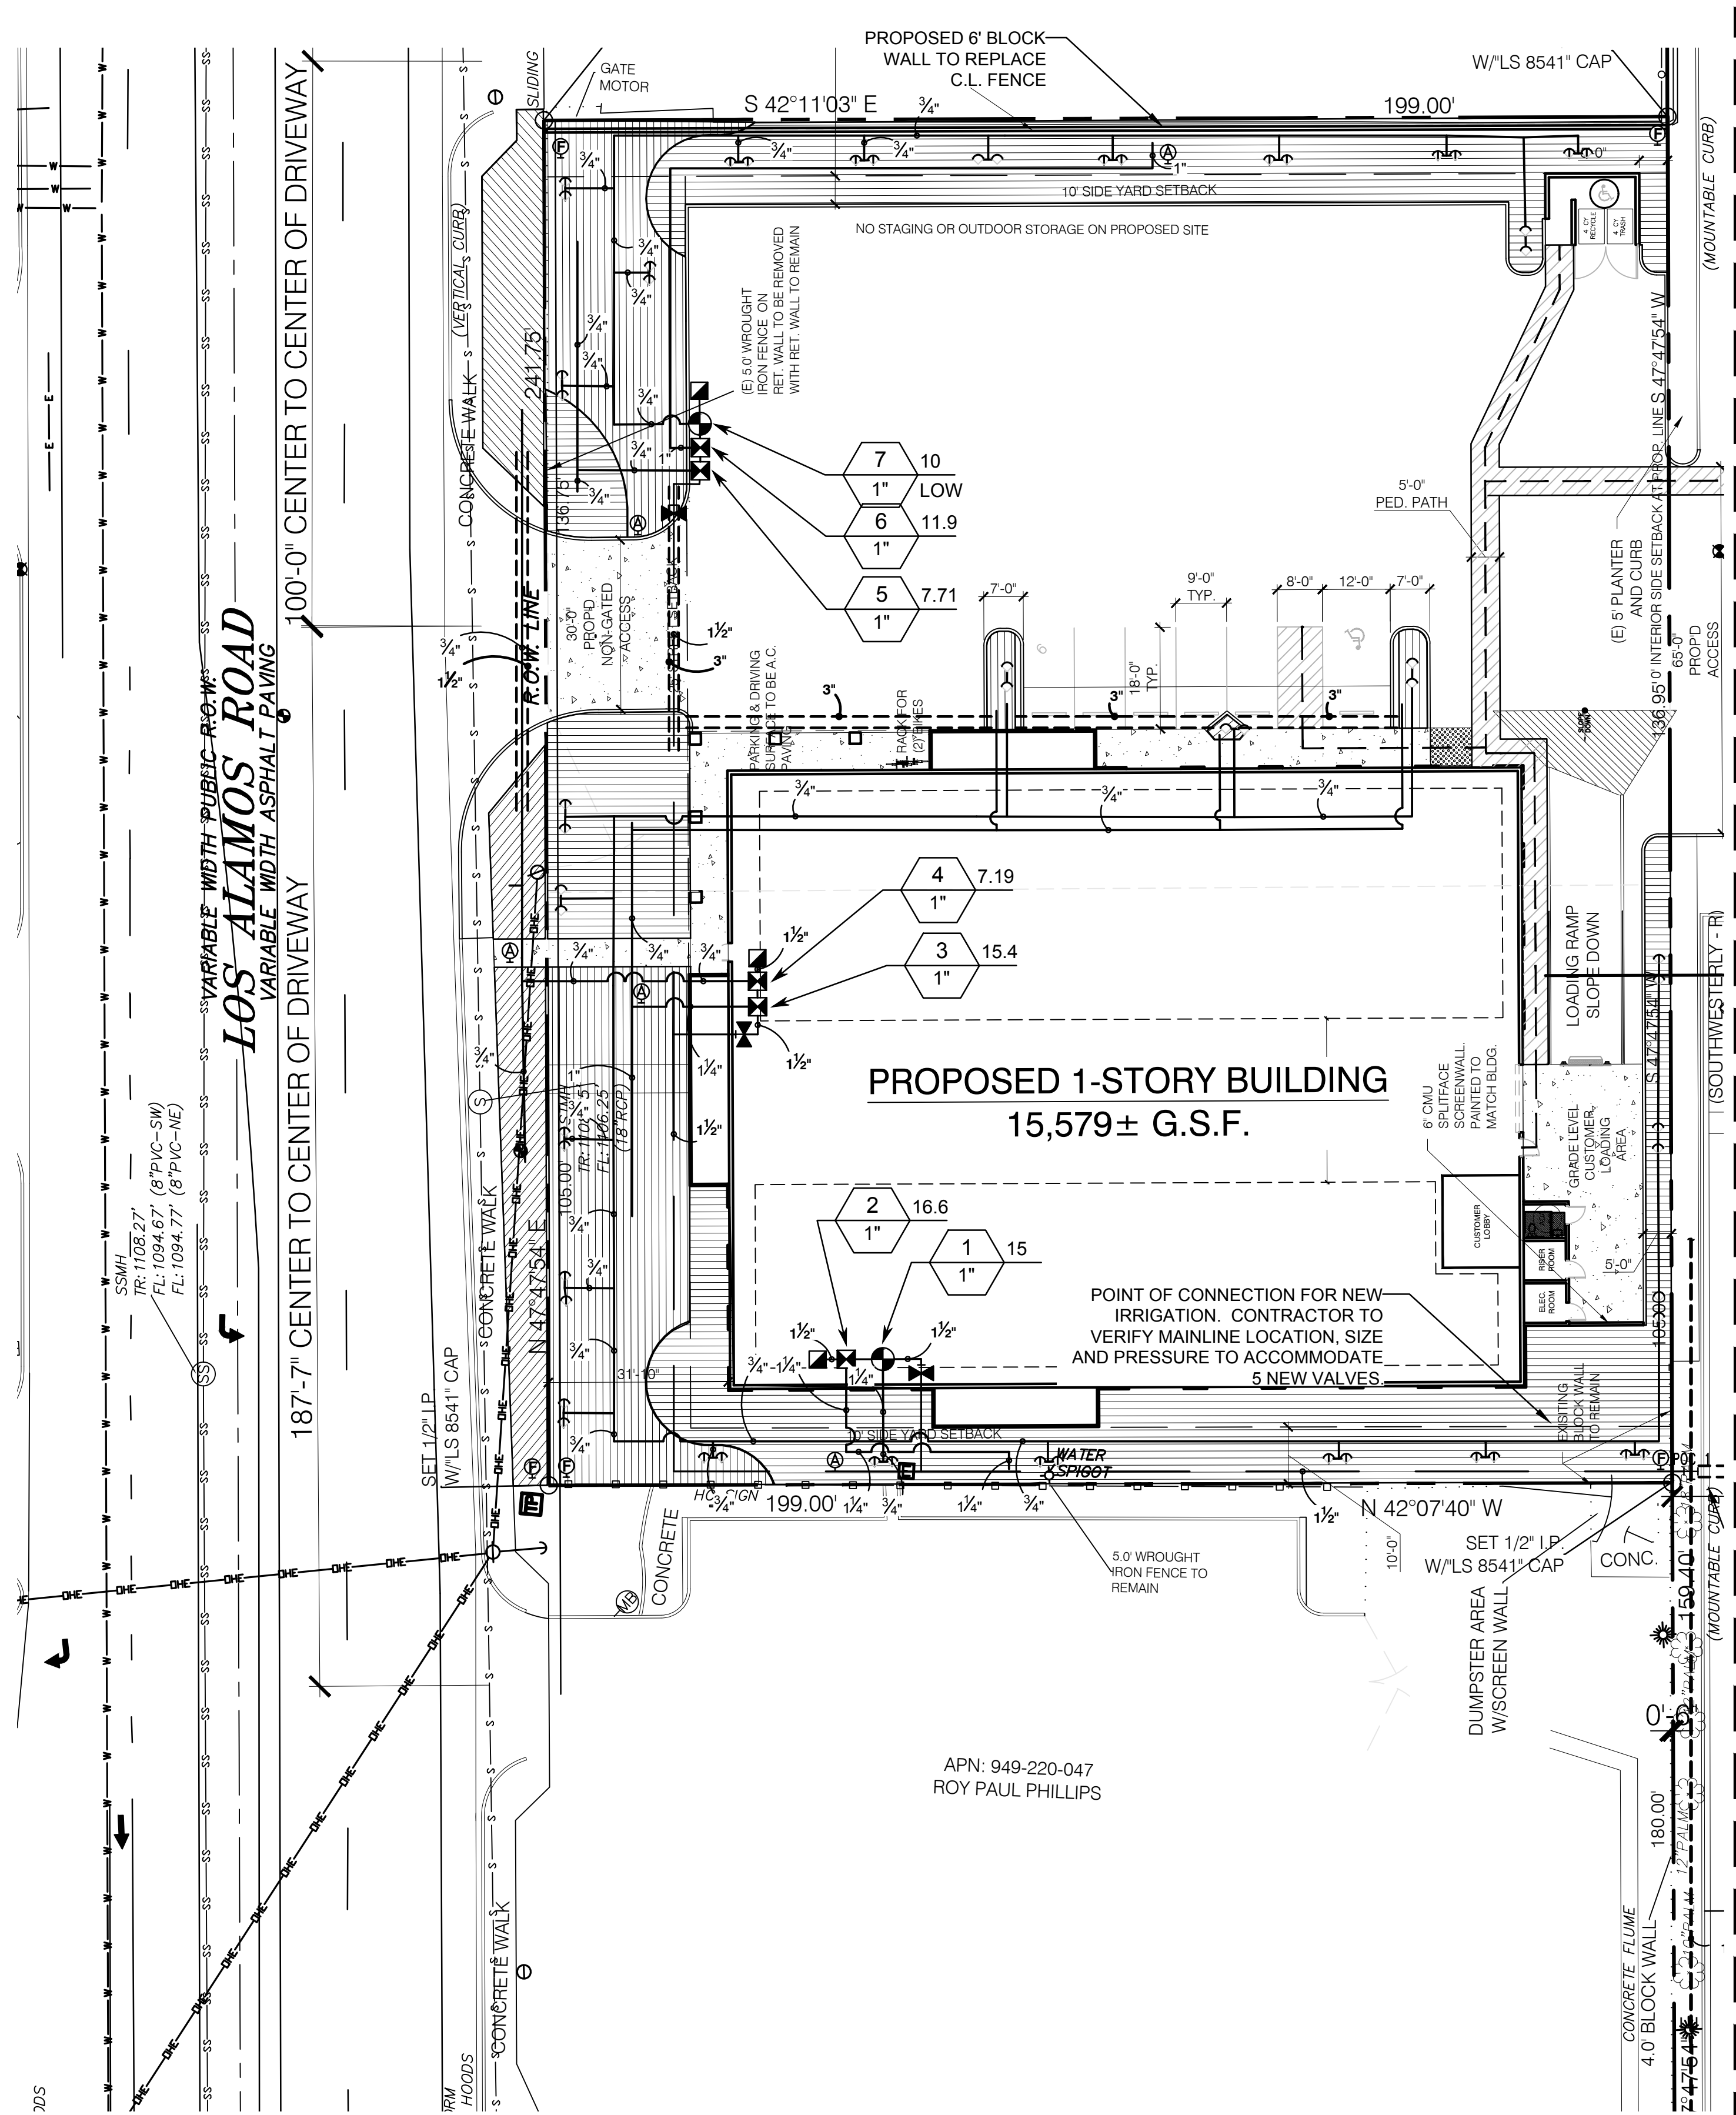

MATCHLINE: SEE SHEET LI-3

MATCHLINE: SEE SHEET LI-2

CRITICAL ANALYSIS


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 P.O.C. NUMBER: 01
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 Point of Connection Size: 1"
 Flow Available: 20.24 GPM
 PRESSURE AVAILABLE
 Static Pressure at POC: 55 PSI
 Pressure Available: 55 PSI
 DESIGN ANALYSIS
 Maximum Station Flow: 14.53 GPM
 Flow Available at POC: 20.24 GPM
 Residual Flow Available: 5.71 GPM
 Critical Station: 6
 Design Pressure: 30 PSI
 Friction Loss: 5.13 PSI
 Fittings Loss: 0.51 PSI
 Elevation Loss: 0 PSI
 Loss through Valve: 9.51 PSI
 Pressure Req. at Critical Station: 45.2 PSI
 Loss for Fittings: 0.16 PSI
 Loss for Main Line: 1.61 PSI
 Loss for POC to Valve Elevation: 0 PSI
 Loss for Backflow: 0 PSI
 Critical Station Pressure at POC: 46.9 PSI
 Pressure Available: 55 PSI
 Residual Pressure Available: 8.07 PSI

REFER TO TITLE SHEET FOR IRRIGATION NOTES

WATER EFFICIENT LANDSCAPE WORKSHEET						
PROJECT:	U-Haul Murrieta - Combined new and existing landscape areas			DATE:	04/15/2023	
This worksheet is filled out by the project applicant and it is a required element of the Landscape Documentation Package.						
Reference Evapotranspiration (ET ₀)	55					
Conversion Factor	0.62					
Hydrozone #	Plant Factor (PF)	Irrigation Method ^a	Irrigation Efficiency (IE) ^b	ETAF (PFIE)	Landscape Area (sq. ft.)	ETAF x Area
Regular Landscape Areas						
Low water use plantings	0.2	Drip	0.81	0.25	23630	5835
Medium water use plantings	0.5	Drip	0.81	0.62	13240	8173
Medium water use trees	0.5	Bubblers	0.75	0.67	176	117
Low use plantings	0.3	Rotary Nozzles or Rotors	0.75	0.40	0	0
Med use plantings	0.5	Rotary Nozzles or Rotors	0.75	0.67	0	0
High water use turf	0.7	Rotary Nozzles or Rotors	0.75	0.93	0	0
				TOTALS	37,046	14,125
Special Landscape Areas						
Turf areas parks				1	0	0
Irrigated w/ recycled water				1	0	0
Water features				1	0	0
				TOTALS	0	0
				ETWU Total	481,654	0
				Maximum Allowed Water Allowance (MAWA) ^c	568,471	
MAWA						
ETAF for residential areas is 0.55 or below for residential areas, and 0.45 or below for non-residential areas.						
MAWA =	ETO *	Conv Factor *	((ETAF * LA) + (1-ETAF) * SLA))			
MAWA =	55	0.62	(37,046 * 0.45 + (1-0.45) * 0)			
MAWA =	568,471					
ETAF Calculations						
Regular Landscape Areas			All Landscape Areas			
Total ETAF x Area	14,125	Total ETAF x Area	14,125			
Total Area	37,046	Total Area	37,046			
Average ETAF	0.38	Stewide ETAF	0.38			

IRRIGATION SCHEDULE

SYMBOL	MANUFACTURER/MODEL/DESCRIPTION	PSI
1402	RAIN BIRD 1804-SAM-PRS-1400 FLOOD 1402 FLOOD BUBBLER 4.0" POPUP WITH CHECK VALVE AND PRESSURE REGULATOR	30
☒	RAIN BIRD XCZ-100-PRB-R WIDE FLOW DRIP CONTROL KIT FOR COMMERCIAL APPLICATIONS. PURPLE CAP DESIGNATES FOR RECLAIMED WATER, NON-POTABLE USE. 1" PESBR VALVE AND 1" PRESSURE REGULATING 40PSI BASKET FILTER. 0.3GPM TO 20GPM.	
⊕	RAIN BIRD MDCFFCAP DRIPLINE FLUSH VALVE PURPLE CAP IN COMPRESSION FITTING COUPLER. FOR NON-POTABLE WATER USE.	
⊕	RAIN BIRD ARV050 1/2" AIR RELIEF VALVE, MADE OF QUALITY RUST-PROOF MATERIALS, WITH A 6.0" DRIP VALVE BOX (SEB 7XB EMITTER BOX). USE WITH INSTALLATION BELOW SOIL. THE VALVE WILL ALLOW AIR TO ESCAPE THE PIPELINE, THUS PREVENTING WATER HAMMER OR BLOCKAGE.	
	AREA TO RECEIVE DRIPLINE RAIN BIRD XFS-CV-06-18 XFS-CV SUB-SURFACE LANDSCAPE DRIPLINE WITH A HEAVY-DUTY 4.3 PSI CHECK VALVE. 0.6 GPH EMITTERS AT 18" O.C. DRIPLINE LATERALS SPACED AT 18" APART, WITH EMITTERS OFFSET FOR TRIANGULAR PATTERN. USE XF INSERT FITTINGS.	
⊕	RAIN BIRD PESB-PRS-D 1", 1-1/2", 2" PLASTIC INDUSTRIAL VALVES. LOW FLOW OPERATING CAPABILITY. GLOBE CONFIGURATION. WITH PRESSURE REGULATING MODULE, AND SCRUBBER TECHNOLOGY FOR RELIABLE PERFORMANCE IN DIRTY WATER IRRIGATION APPLICATIONS.	
☑	NELSON 7645 1" BRASS QUICK COUPLER VALVE WITH ACME THREADS FOR SLOW FLOW CONTROL. WITH LOCKING RUBBER COVER AND PURPLE CAP WITH RECLAIMED WATER WARNING.	
⊕	EXISTING BUCKNER-SUPERIOR 3200-RW 2" 1" BUCKNER-SUPERIOR 3200-RW NORMALLY CLOSED BRASS MASTER VALVE. PURPLE CROSS HANDLE FOR RECLAIMED WATER USE.	
⊕	EXISTING FEBCO 825YA 1" REDUCED PRESSURE BACKFLOW PREVENTER	
⊕	RAIN BIRD ESP8LXME WITH (01) ESPLXMSM12 20 STATION COMMERCIAL CONTROLLER. MOUNTED ON A PLASTIC WALL MOUNT. WITHOUT FLOW SENSING.	
⊕	RAIN BIRD WR2-RFC WIRELESS RAIN AND FREEZE SENSOR COMBO. INCLUDES 1 RECEIVER AND 1 RAIN/FREEZE SENSOR TRANSMITTER.	
⊕	POINT OF CONNECTION 1"	
POC 1	POINT OF CONNECTION 1"	
---	IRRIGATION LATERAL LINE: PVC SCHEDULE 40-NP	
---	IRRIGATION MAINLINE: EXISTING SCH 40 MAINLINE - CONTRACTOR TO LOCATE IN FIELD, CONFIRM SIZE AND MAKE CONNECTION FOR FUTURE LANDSCAPE ON LI-1	
---	IRRIGATION MAINLINE: PVC SCHEDULE 40 MAINLINE 12" BELOW GRADE	
---	PIPE SLEEVE: PVC SCHEDULE 40	

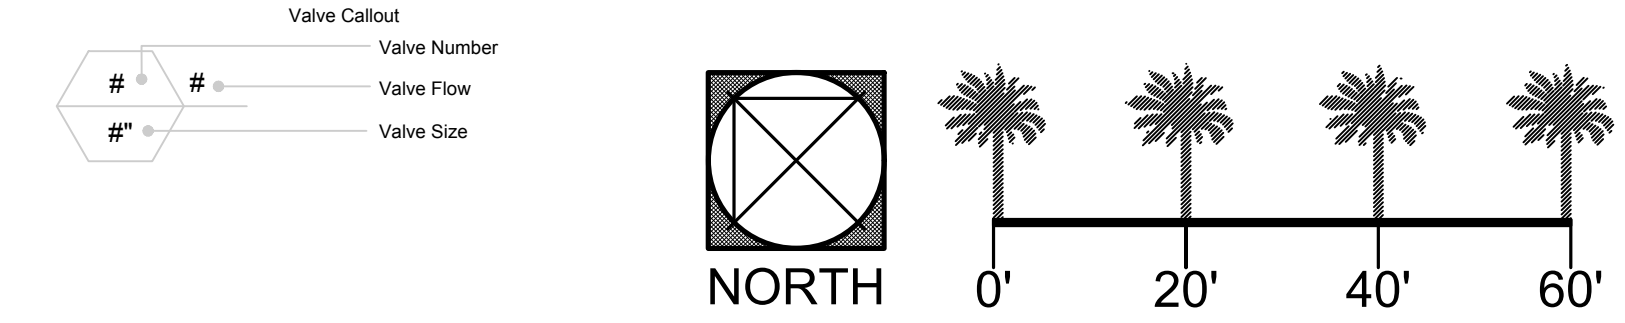

PREPARED FOR:
AMERCO REAL ESTATE COMPANY
 2727 N. CENTRAL AVE. 9-N
 PHOENIX, AZ. 85004


Underground Service Alert
 Call: TOLL FREE
 1-800-422-4133
 TWO WORKING DAYS BEFORE YOU DIG

"AS BUILT"
 THE RECEIPT OF AS-BUILT PLANS AND CITY'S ACCEPTANCE THEREOF DOES NOT ABSOLVE THE ENGINEER OF WORK OF ANY RESPONSIBILITY FOR THE PROJECT DESIGN.
 ENGINEER OF WORK: _____ DATE: _____
 RCE NO. _____ EXPIRATION DATE: _____
 APPROVED FOR SIGNATURE: _____
 PLAN CHECK ENGR. NAME TYPED: _____ DATE: _____
 PLAN CHECK FIRM: _____ RCE NO. _____
 DATUM: _____

REGISTERED LANDSCAPE ARCHITECT
 bmla LANDSCAPE ARCHITECTURE
 310 NORTH JOY STREET | CORONA, CA 92679
 T: 951.737.1124 | F: 951.737.6551
 AS NOTED PREPARED BY: _____ DATE: _____
 VERTICAL STEVE SHIRREL
 AS NOTED CA LIC NO. 5062 EXP. DATE 12/31/24


DATE	INITIAL	REVISION DESCRIPTION

SHEET 2 CITY OF MURRIETA SHEETS 11
NEW IRRIGATION PLAN
 U-HAUL OF MURRIETA
 MURRIETA, CA 92562
 APPROVED: _____ DATE: _____
 DIRECTOR OF PUBLIC WORKS / CITY ENGINEER RCE
 DWN BY: _____ PROJECT NO. _____ DRAWING NO. LI-1
 CHKD BY: _____
 FIELD BK: _____

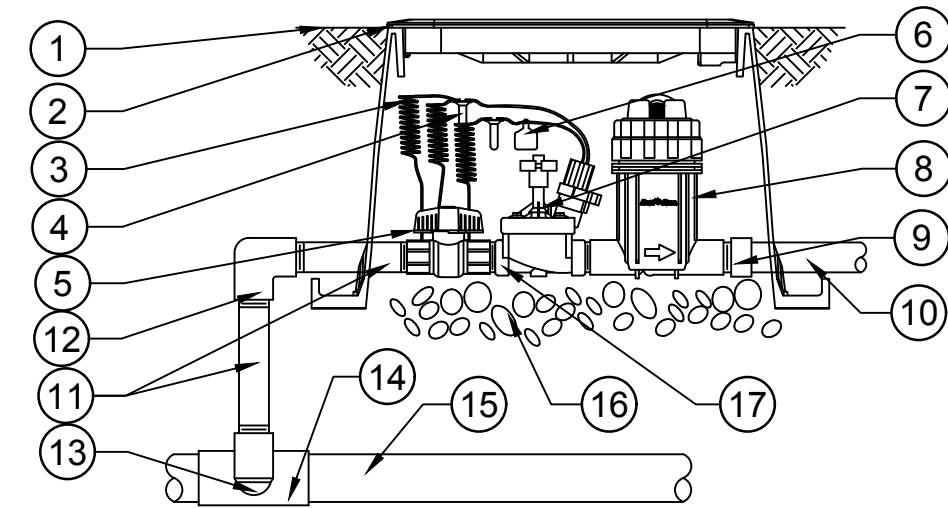


- LEGEND:**
1. FINISH GRADE/TOP OF MULCH
 2. VALVE BOX WITH COVER: RAIN BIRD VB-STD
 3. 30" LIN LENGTH OF WIRE, COILED
 4. WATERPROOF CONNECTION: RAIN BIRD DB SERIES
 5. 1" BALL VALVE (INCLUDED IN KIT)
 6. ID TAG
 7. REMOTE CONTROL VALVE: RAIN BIRD PESB (INCLUDED IN KIT)
 8. PRESSURE REGULATING QUICK CHECK BASKET FILTER: RAIN BIRD PRB-QKCHK-100 (INCLUDED IN KIT)
 9. PVC SCH 40 FEMALE ADAPTOR
 10. LATERAL PIPE
 11. PVC SCH 80 NIPPLE (LENGTH AS REQ)
 12. PVC SCH 40 ELL
 13. PVC SCH 80 NIPPLE (2" LENGTH, HIDDEN) AND PVC SCH 40 ELL
 14. PVC SCH 40 TEE OR ELL
 15. MAINLINE PIPE
 16. 3" MIN DEPTH OF 3/4" WASHED GRAVEL
 17. PVC SCH 80 NIPPLE, CLOSE (INCLUDED IN KIT)

1 XCZ-PRB-100-COM
1/2" = 1'-0"

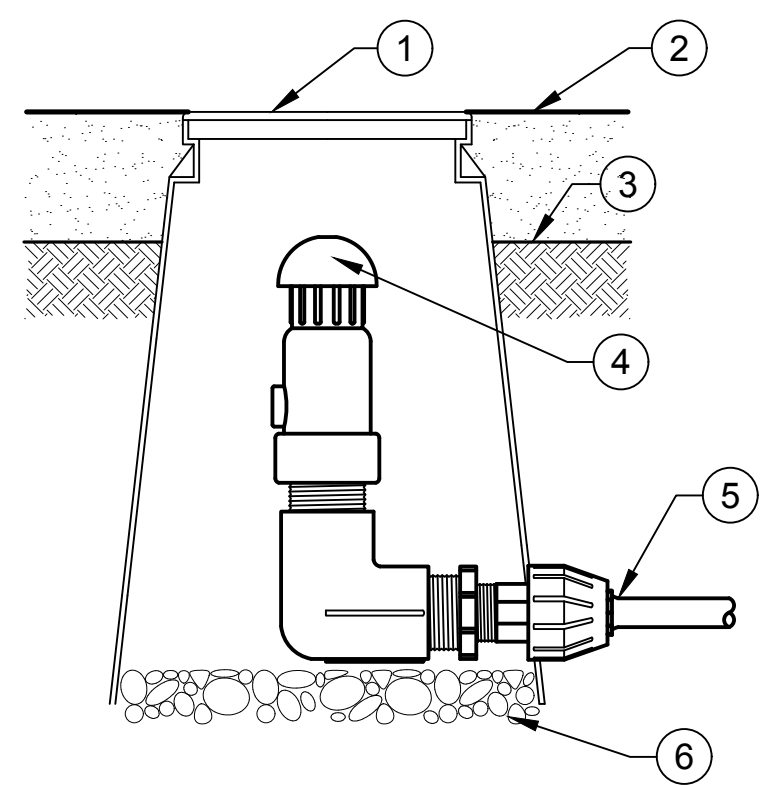


- LEGEND:**
1. 6" ROUND VALVE BOX: RAINBIRD VB-6RND
 2. TOP OF MULCH
 3. FINISH GRADE
 4. AIR RELIEF VALVE KIT: RAINBIRD X17000AIR VALVE KIT
 5. LANDSCAPE DRIPLINE TUBING: RAINBIRD DRIPLINE XFS
 6. 3" MINIMUM DEPTH OF 3/4" WASHED GRAVEL

2 AIR RELIEF VALVE
1" = 1'-0"

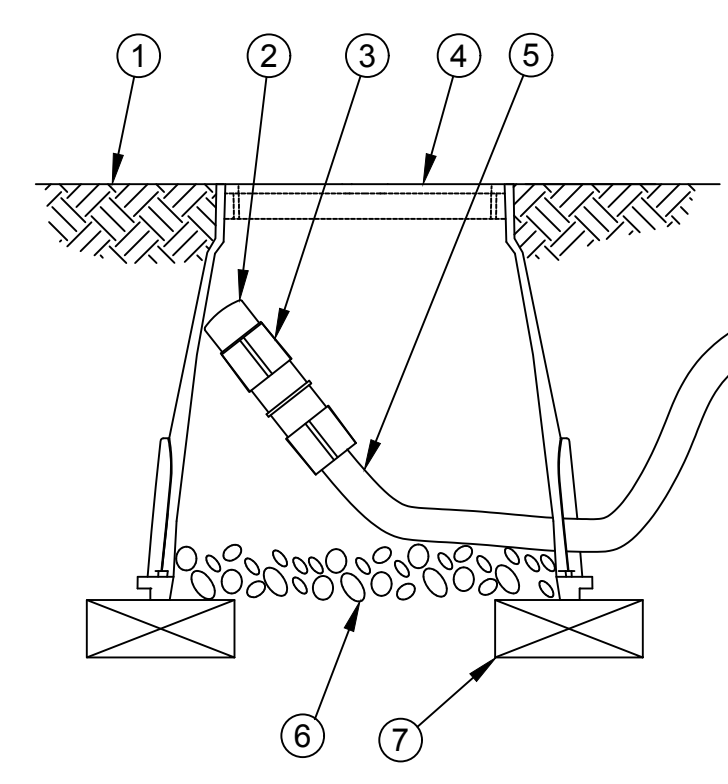



- LEGEND:**
1. FINISH GRADE
 2. FLUSH CAP FOR EASY FIT COMPRESSION FITTINGS: POTABLE: RAIN BIRD MDCFCAP NON-POTABLE: RAIN BIRD MDCFCPCAP
 3. EASY FIT COUPLING: RAIN BIRD MDCFCOUP
 4. SUBTERRANEAN EMITTER BOX: RAIN BIRD SEB 7XB
 5. SUB-SURFACE DRIPLINE: RAIN BIRD XF SERIES DRIPLINE POTABLE: XFS DRIPLINE NON-POTABLE: XFS-P DRIPLINE
 6. 3-INCH MINIMUM DEPTH OF 3/4-INCH WASHED GRAVEL
 7. BRICK (1 OF 2)

3 DRIP FLUSH POINT
1" = 1'-0"

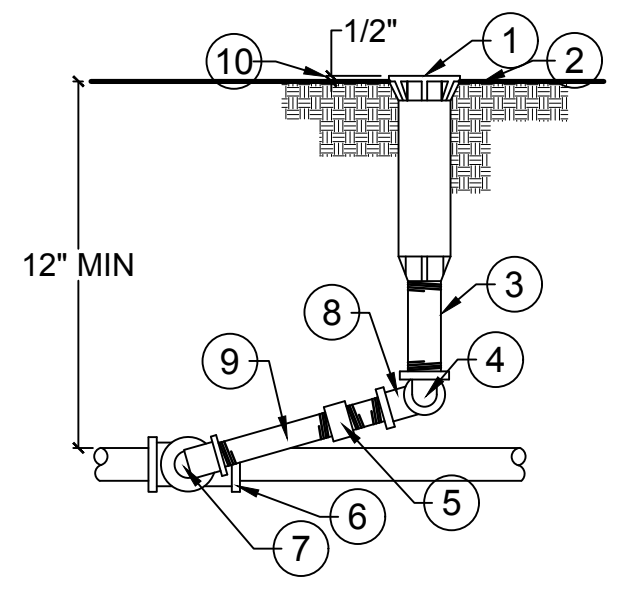

- LEGEND:**
1. POP-UP HEAD W/ FLOOD BUBBLER.
 2. FINISH GRADE.
 3. SCH 80 PVC NIPPLE-LENGTH AS NECESSARY.
 4. SCH 40 PVC TXT 90 DEGREE ELL.
 5. ANTI-DRAIN VALVE-ALL DOWN SLOPE HEADS IF NOT INSTALLED IN HEADS.
 6. NON-PRESSURE LATERAL LINE AND FITTING.
 7. MARLEX 90 DEGREE STREET ELL.
 8. MARLEX 90 DEGREE STREET ELL.
 9. SCH 80 PVC NIPPLE (6" LONG).
 10. 1/2" ABOVE FINISH GRADE.

4 POP-UP FLOOD BUBBLER
1/2" = 1'-0"

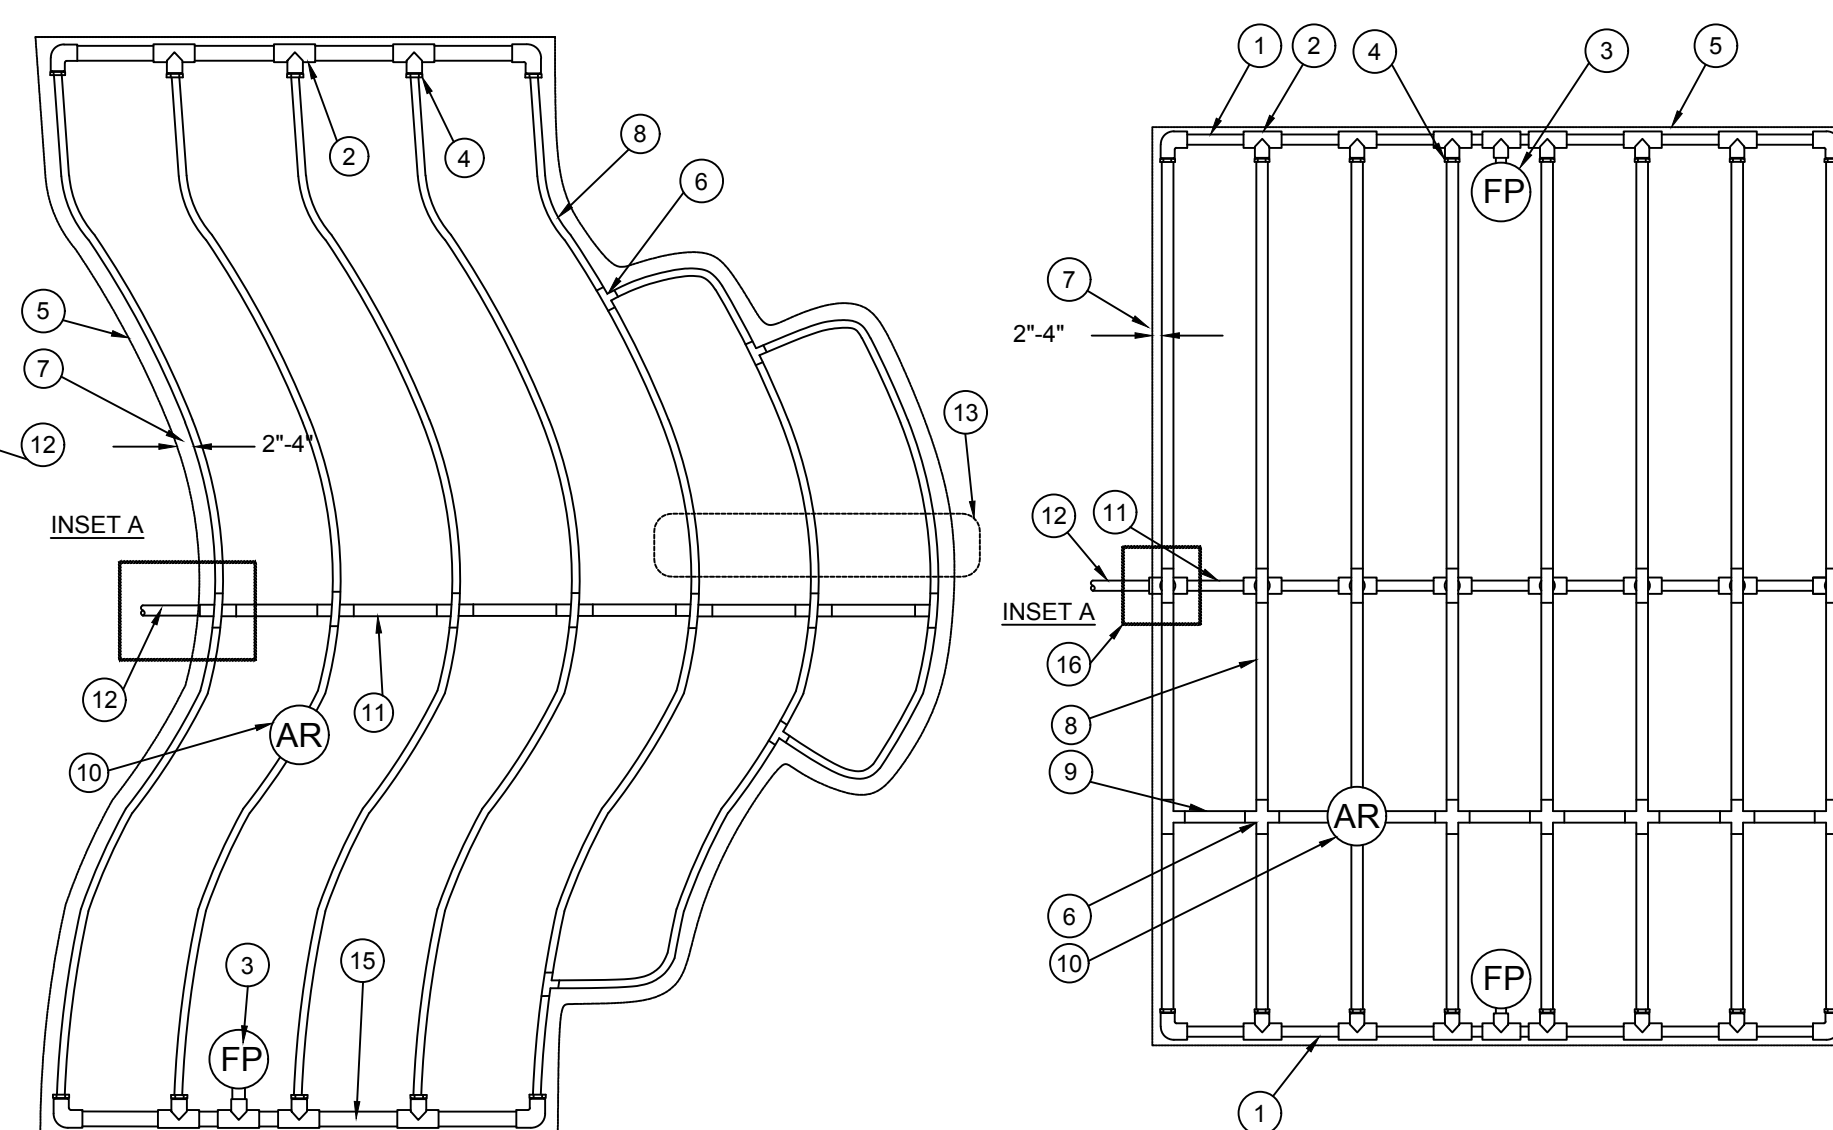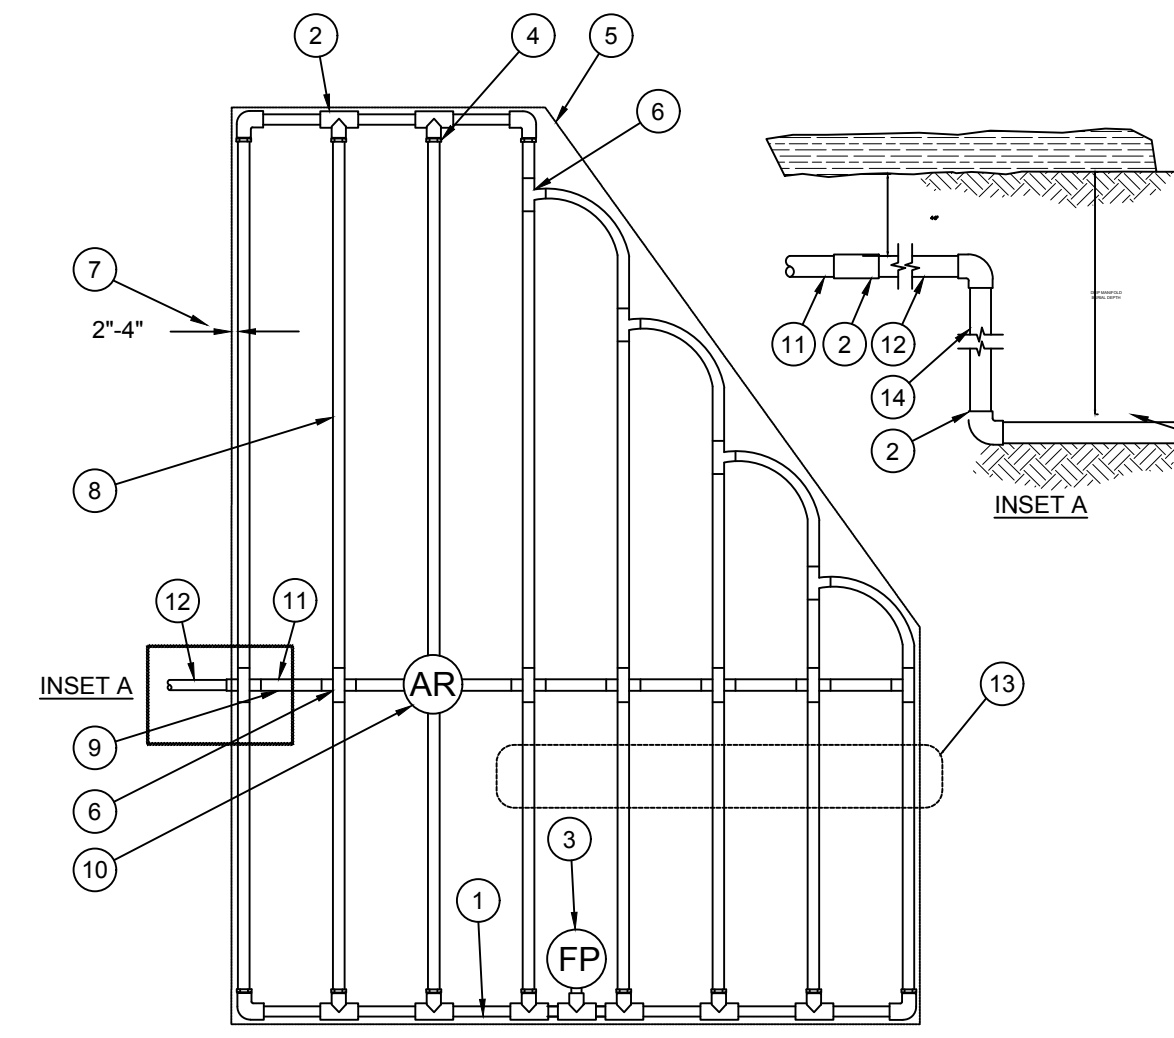

NOTES:


1. DISTANCE BETWEEN LATERAL ROWS AND EMITTER SPACING TO BE BASED ON SOIL TYPE, PLANT MATERIALS AND CHANGES IN ELEVATION.
2. LENGTH OF LONGEST DRIPLINE LATERAL SHOULD NOT EXCEED THE MAXIMUM LENGTH SHOWN IN THE ACCOMPANYING TABLE.
3. AIR RELIEF VALVE TO BE INSTALLED AT HIGH POINT OF AREA.

PSI	12" Spacing		18" Spacing		24" Spacing	
	0.6 GPH	0.9 GPH	0.6 GPH	0.9 GPH	0.6 GPH	0.9 GPH
15	273	155	314	250	424	322
20	318	169	353	294	508	368
30	360	230	413	350	586	414
40	395	255	465	402	652	474
50	417	285	528	420	720	488
60	460	290	596	455	780	512

WHEN USING 17MM INSERT FITTINGS WITH DESIGN PRESSURE OVER 50PSI, IT IS RECOMMENDED THAT STAINLESS STEEL CLAMPS BE INSTALLED ON EACH FITTING.


- LEGEND:**
1. PVC EXHAUST HEADER
 2. PVC SCH 40 TEE OR EL (TYPICAL)
 3. FLUSH POINT (TYPICAL)
 4. BARB X MALE FITTING
 5. PERIMETER OF AREA
 6. BARB X BARB INSERT TEE OR CROSS
 7. PERIMETER DRIPLINE PIPE TO BE INSTALLED 2'-4" FROM PERIMETER OF AREA
 8. SUB-SURFACE DRIPLINE
 9. 1/2" POLYETHYLENE BLANK TUBING
 10. AIR RELIEF VALVE
 11. PVC SUPPLY MANIFOLD
 12. PVC SUPPLY PIPE FROM CONTROL ZONE KIT (SIZED TO MEET LATERAL FLOW DEMAND)
 13. TOTAL LENGTH OF SELECTED DRIPLINE SHOULD NOT EXCEED LENGTH SHOWN IN TABLE
 14. PVC SCH 40 RISER PIPE
 15. PVC FLUSH HEADER
 16. CONNECTION FROM SUPPLY MANIFOLD TO DRIPLINE
 17. BARB X FEMALE FITTING
 18. 3/4" PVC NIPPLE, LENGTH AS NECESSARY

5 DRIPLINE LAYOUT
1/2" = 1'-0"

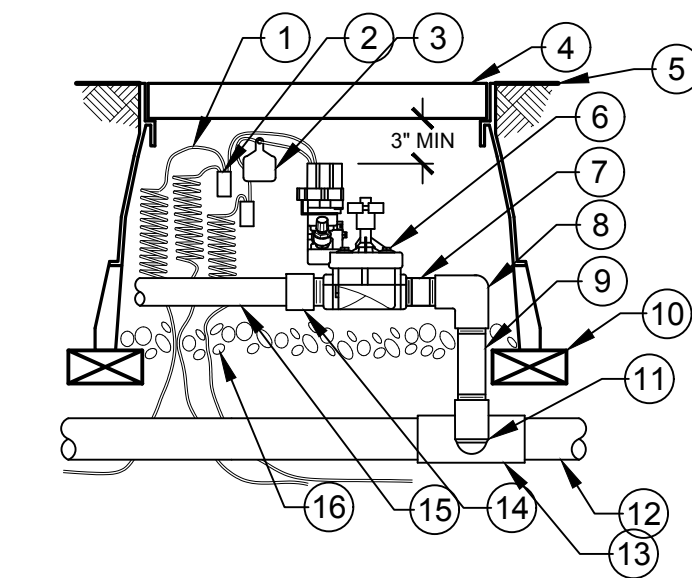

- LEGEND:**
1. 30-INCH LINEAR LENGTH OF WIRE, COILED
 2. WATER PROOF CONNECTION (1 OF 2)
 3. ID TAG
 4. VALVE BOX WITH COVER: 12-INCH SIZE
 5. FINISH GRADE/TOP OF MULCH
 6. REMOTE CONTROL VALVE
 7. PVC SCH 80 NIPPLE (CLOSE)
 8. PVC SCH 40 ELL
 9. PVC SCH 80 NIPPLE (LENGTH AS REQUIRED)
 10. BRICK (1 OF 4)
 11. SCH 80 NIPPLE (2-INCH LENGTH, HIDDEN) AND SCH 40 ELL
 12. PVC MAINLINE PIPE
 13. PVC SCH 40 TEE OR ELL
 14. PVC SCH 40 MALE ADAPTER
 15. PVC LATERAL PIPE
 16. 3.0-INCH MINIMUM DEPTH OF 3/4-INCH WASHED GRAVEL

6 REMOTE CONTROL VALVE
1" = 1'-0"

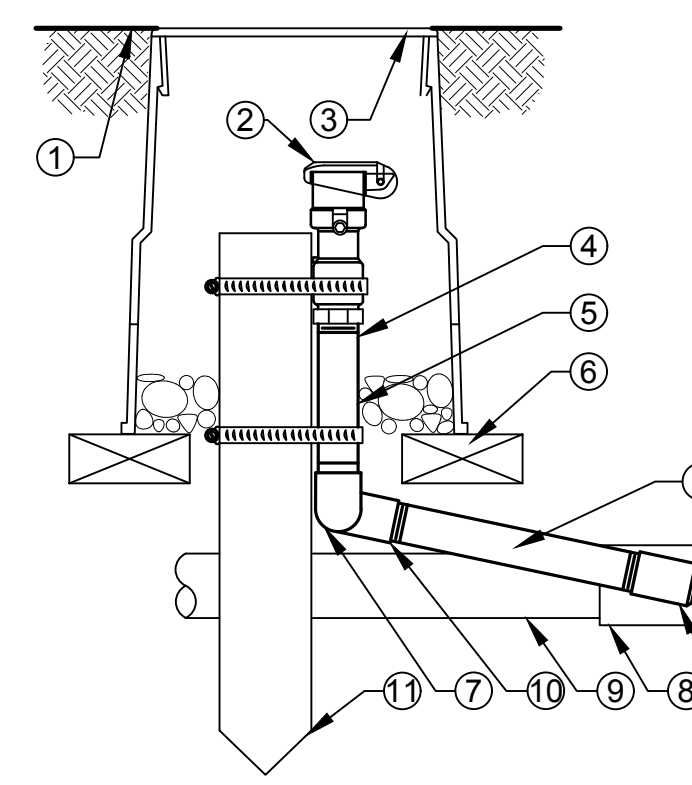

- LEGEND:**
1. FINISH GRADE/TOP OF MULCH
 2. QUICK-COUPLING VALVE
 3. VALVE BOX WITH COVER: RAIN BIRD VB-6RND
 4. PVC SCH 80 NIPPLE (LENGTH AS REQUIRED)
 5. 3 INCH MIN. DEPTH OF 3/4" WASHED GRAVEL
 6. BRICK (1 OF 2)
 7. PVC SCH 40 STREET ELL
 8. PVC SCH 40 TEE OR ELL
 9. PVC MAINLINE PIPE
 10. PVC SCH 40 ELL
 11. 2" X 2" REDWOOD STAKE WITH STAINLESS STEEL GEAR CLAMPS OR EQUIVALENT SUPPORT SYSTEM

NOTE:
FURNISH FITTINGS AND PIPING NOMINALLY SIZED IDENTICAL TO NOMINAL QUICK COUPLING VALVE INLET SIZE.

7 QUICK COUPLER
1" = 1'-0"

"AS BUILT"

THE RECEIPT OF AS-BUILT PLANS AND CITY'S ACCEPTANCE THEREOF DOES NOT ABSOLVE THE ENGINEER OF WORK OF ANY RESPONSIBILITY FOR THE PROJECT DESIGN.


ENGINEER OF WORK _____ DATE _____

RCE NO. _____ EXPIRATION DATE _____

APPROVED FOR SIGNATURE _____

PLAN CHECK ENGR. NAME TYPED _____ DATE _____

PLAN CHECK FIRM RCE NO. _____

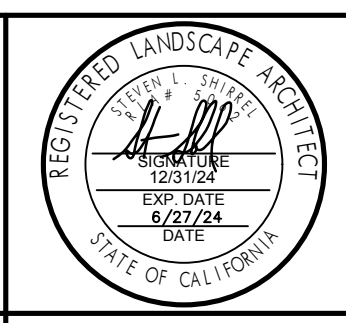

bmla
LANDSCAPE ARCHITECTURE

310 NORTH JOY STREET | CORONA, CA 92679
T: 951.737.1124 | F: 951.737.6551

DATE	INITIAL	REVISION DESCRIPTION	SHT. NO.	DATE	INITIAL

SHEET 5 CITY OF MURRIETA SHEETS 11

IRRIGATION DETAILS

U-HAUL OF MURRIETA
MURRIETA, CA 92562

APPROVED _____ DATE _____

DIRECTOR OF PUBLIC WORKS / CITY ENGINEER RCE

DWN BY: _____ PROJECT NO. _____ DRAWING NO. LID-1


CHKD BY: _____

FIELD BK: _____

PREPARED FOR:

AMERCO REAL ESTATE COMPANY

2727 N. CENTRAL AVE. 9-N
PHOENIX, AZ. 85004

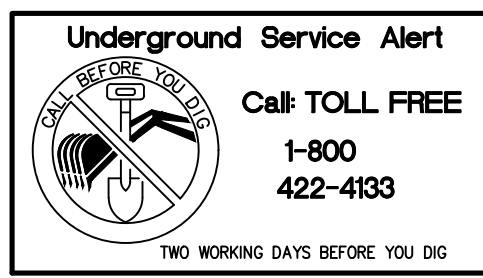

BENCH MARK DESCRIPTION: _____

LOCATION: _____

RECORDED: _____

ELEVATION: _____ DATUM: _____

APPROVED FOR SIGNATURE _____

PLAN CHECK ENGR. NAME TYPED _____ DATE _____

PLAN CHECK FIRM RCE NO. _____

AS NOTED _____

VERTICAL _____

AS NOTED _____

PREPARED BY _____ DATE _____

STEVE SHIRREL
CA LIC NO. 5062 EXP. DATE 12/31/24

IRRIGATION SYSTEM

I. GENERAL

- A. SCOPE OF WORK
Provide all labor, materials, equipment, and services necessary to furnish and install Irrigation System as shown on the drawings and described herein.
B. QUALITY ASSURANCE AND REQUIREMENTS
1. Permits and Fees
The Contractor shall obtain and pay for any and all permits and all inspections as required.
2. Manufacturer's Directions
Manufacturer's directions and detailed drawings shall be followed in all cases where the manufacturers of articles used in this contract furnish directions covering points not showing the drawings and specifications.
3. Ordinances and Regulations
All local, municipal and state laws, and rules and regulations governing or relating to any portion of this work are hereby incorporated into and made a part of these specifications and their provisions shall be carried out by the Contractor.
4. Explanation of Drawings
Contractor is responsible for all offsets, fittings, sleeves, etc., which may be required but are not indicated.
C. Submittals
1. Material List
Furnish the articles, equipment, materials, or processes specified by name in the drawings and specifications.
2. Record Drawings
The landscape contractor shall request in writing from the landscape architect the documents necessary to proceed with the preparation of the as-builts.
3. Controller Charts
Record drawings shall be approved by the Architect before controller charts are prepared.
4. Operation and Maintenance Manuals
Prepare and deliver operation and maintenance manuals as specified in Division 1 and as follows:
5. Material to Be Furnished
Supply as a part of this Contract the following tools:
a. Two sets of special tools required for removing, disassembling and adjusting each type of sprinkler and valve supplied on this project.
b. Two five-foot valve keys for operation of gate valves.
c. Two keys for each automatic controller.
d. Six quick coupler keys and matching hose swivels for each type of quick coupling valve installed.

- d. Solvent cement and primer for PVC solvent-weld pipe and fittings shall be of type and installation methods prescribed by the manufacturer.
e. All PVC pipe shall bear the following markings:
(1) Manufacturer's name.
(2) Nominal pipe size.
(3) Schedule or class.
(4) Pressure rating in PSI.
(5) NSF (National Sanitation Foundation) approval.
f. All fittings shall bear the manufacturer's name or trademark material designation, size, applicable I.P.S. schedule and NSF seal of approval.
3. PVC Non-Pressure Lateral Line Piping
Non-pressure buried lateral line piping shall be PVC class 200 with solvent weld joints.
b. Pipe shall be made from NSF approved, Type 1, Grade II PVC compound conforming to ASTM resin specification D1784. All pipe shall meet requirements set forth in Federal Specification PS-22-70, with an appropriate standard dimension ratio.
c. Except as noted in Section II-A-a & b, all requirements for non-pressure lateral line pipe and fittings shall be the same as for solvent-weld pressure main line pipe and fittings as set forth in Section II-A-2 of these specifications.
4. Brass Pipe and Fittings
a. Where indicated on the drawings, use red brass screwed pipe conforming to Federal Specification #WW-P-351.
b. Fittings shall be red brass conforming to Federal Specification #WW-P-460.
5. Galvanized Pipe Fittings
a. Where indicated on the drawings, use galvanized steel pipe ASA Schedule 40 mild steel screwed pipe.
b. Fittings shall be medium galvanized screwed beaded malleable iron. Galvanized couplings may be merchant coupling.
c. All galvanized pipe fittings installed below grade shall be painted with two (2) coats of Koppeers "#50 Bitumastic."
6. Gate Valves
a. Gate valves 3" and smaller shall be 125 lb. SWP bronze gate valve with screw-in bonnet, non-rising stem and solid wedge disc.
b. Gate valves 3" and smaller shall be threaded ends and shall be equipped with a bronze hand wheel.
c. Gate valves 3" and smaller shall be similar to those manufactures by Nicco or approved equal.
d. All gate valves shall be installed per installation detail.
7. Quick Coupling Valves
Quick coupling valves shall have a brass two-piece body designed for working pressure of 150 P.S.I. operable with quick coupler. Key size and type shall be as shown on plans.
8. Backflow Prevention Units
a. Backflow prevention units shall be of size and type indicated on the irrigation drawings.
9. Check Valves
Anti-drain valves shall be of heavy-duty virgin PVC construction with F.I.P. thread inlet and outlet. Internal parts shall be stainless steel and neoprene.
10. Control Wiring
a. Connections between the automatic controllers and the electric control valves shall be made with direct burial copper wire AWG-U.F. 600 volt.
11. Automatic Controllers
a. Automatic controllers shall be of size and type shown on the Plans.
12. Electric Control Valves
a. All electric control valves shall be the same manufacturer as the automatic controllers.
13. Control Valve Boxes
a. Use 9 by 24 inch round box for all gate valves, Brooks #9 or approved equal.
14. Sprinkler Heads
a. All sprinkler heads shall be of the same size, type, and deliver the same rate of precipitation with the diameter (or radius) of throw, pressure, and discharge as shown on the plans and/or specified on these special provisions.
b. Spray heads shall have a screw adjustment.
c. Riser units shall be fabricated in accordance with the details.
d. Riser nipples for all sprinkler heads shall be the same size as the riser opening in the sprinkle . All sprinkler heads

- 3. Trenching and Back fill Under Paving
a. Trenches located under areas where paving, asphalt concrete or concrete shall be back filled with sand (a layer six inches below the pipe and three inches above the pipe) and compacted in layers to 90%.
b. Generally, piping under existing walks is done by jacking, boring or hydraulic driving, but where any cutting or breaking of sidewalks and/or concrete is necessary, it shall be done and replaced by the Contractor as part of the Contract cost.
4. Assemblies
a. Routing of sprinkler irrigation lines as indicated on the drawings is diagrammatic.
5. Line Clearance
All lines shall have a minimum clearance of six inches from each other and from lines of other trades.
6. Automatic Controller
a. Install controller in a vandol proof enclosure.
7. High Voltage Wiring for Automatic Controller
a. 120-volt power connection to the automatic controller shall be provided by the Irrigation Contractor.
8. Remote Control Valves
Install wire where shown on drawings and details.
9. Flushing of System
a. After all new sprinkler pipe lines and risers are in place and connected, all necessary diversion work has been completed, and prior to installation of sprinkler heads the control valves shall be opened and a full head of water used to flush out the system.
10. Sprinkler Heads
a. Install the sprinkler heads as designated on the drawings.
b. Spacing of heads shall not exceed the maximum indicated on the drawings.
D. TEMPORARY REPAIRS
The Owner reserves the right to make temporary repairs as necessary to keep the sprinkler system equipment in operating condition.
E. EXISTING TREES
Where it is necessary to excavate adjacent to existing trees, the Contractor shall use all possible care to avoid injury to trees and tree roots.
F. FIELD QUALITY CONTROL
1. Adjustment of the System
a. The Contractor shall flush and adjust all sprinkler heads for optimum performance and to prevent over spray onto walks, roadways, and buildings as much as possible.
2. Testing of Irrigation System
a. The Contractor shall request the presence of the Architect in writing at least 48 hours in advance of testing.
b. Test all pressure lines under hydrostatic pressure of 150 pounds per square inch and prove watertight.
G. MAINTENANCE
1. The entire sprinkler irrigation system shall be under full automatic operation for a period of seven days prior to any planting.
2. The Architect reserves the right to waive or shorten the operation period.
H. CLEANUP
Cleanup shall be made as each portion of work progresses.
I. FINAL OBSERVATION PRIOR TO ACCEPTANCE
1. The contractor shall operate each system in its entirety for the Architect at time of final observation.
2. The Contractor shall show evidence to the Architect that the Owner has received all accessories, charts, record drawings, and equipment as required before final observation can occur.
J. OBSERVATION SCHEDULE
1. Contractor shall be responsible for notifying the Architect in advance for the following observations according to the time indicated:
a. Pre-Job Conference - 7 days.
b. Pressure supply line installation and testing - 48 hours.
c. Automatic Controller installation - 48 hours.
d. Control wire installation - 48 hours.
e. Lateral line and sprinkler installation - 48 hours.
f. Coverage test - 48 hours.
g. Final observation - 7 days.
2. When inspections have been conducted by other than the Architect, show evidence of when and by whom these inspections were made.
3. No final observation shall commence without as-built drawings.
END OF SECTION


D. PRODUCT DELIVERY, STORAGE AND HANDLING
Handling of PVC Pipe and Fittings: The Contractor is cautioned to exercise care in handling, loading, unloading, and storing of PC pipe and fittings. All PVC pipe shall be transported in a vehicle which allows the length of pipe to lie flat so as not to subject it to undue bending or concentrated external load at any point.
E. GUARANTEE
The guarantee for the sprinkler irrigation shall be made in accordance with the form shown below. A copy of the guarantee form shall be included in the operations and maintenance manual.

GUARANTEE FOR SPRINKLER IRRIGATION SYSTEM
We hereby guarantee that the sprinkler irrigation system we have furnished and installed is free from defects in materials and workmanship, and the work has been completed in accordance with the drawings and specifications.
We agree to repair or replace any defects in material or workmanship which may develop during the period of one year from date of acceptance and also to repair or replace any damage resulting from the repairing or replacing of such defects at no additional cost to the Owner.

PROJECT: _____
LOCATION: _____
SIGNED: _____
CONTRACTOR: _____
ADDRESS: _____
PHONE: _____ DATE OF ACCEPTANCE: _____

- II. PRODUCTS
A. MATERIALS
1. General: Use only new materials of brands and types noted on drawings, specified herein, or approved equals.
2. PVC Pressure Main Line Pipe and Fittings
a. Pressure main line piping for all sizes shall be PVC Schedule 40.
b. Pipe shall be made from NSF approved Type 1, Grade 1 PVC compound conforming to ASTM resin specification 1785.
c. Solvent-weld fittings shall be Schedule 40, 1-2, 11-1 NSF approved conforming to ASTM test procedure D2466.


AS BUILT
THE RECEIPT OF AS-BUILT PLANS AND CITY'S ACCEPTANCE THEREOF DOES NOT ABSOLVE THE ENGINEER OF WORK OF ANY RESPONSIBILITY FOR THE PROJECT DESIGN.
ENGINEER OF WORK: _____ DATE: _____
RCE NO. _____ EXPIRATION DATE: _____
APPROVED FOR SIGNATURE: _____
PLAN CHECK ENGR. NAME: _____ TYPE: _____ DATE: _____
PLAN CHECK FIRM: _____ RCE NO. _____
DATE: _____ INITIAL: _____
ENGINEER OF WORK: _____ REVISION DESCRIPTION: _____
SHT. NO. _____ DATE: _____ INITIAL: _____
CITY APPROVAL: _____

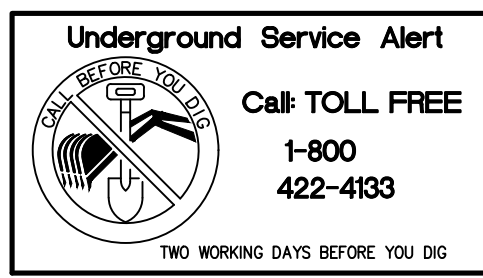

BENCH MARK
DESCRIPTION: _____
LOCATION: _____
RECORDED: _____
ELEVATION: _____ DATUM: _____



SHEET 6 CITY OF MURRIETA SHEETS 11
IRRIGATION SPECIFICATIONS
U-HAUL OF MURRIETA MURRIETA, CA 92562
APPROVED _____ DATE _____
DIRECTOR OF PUBLIC WORKS / CITY ENGINEER RCE
DWN BY: _____ PROJECT NO. _____ DRAWING NO. LIS-1
CHKD BY: _____
FIELD BK: _____

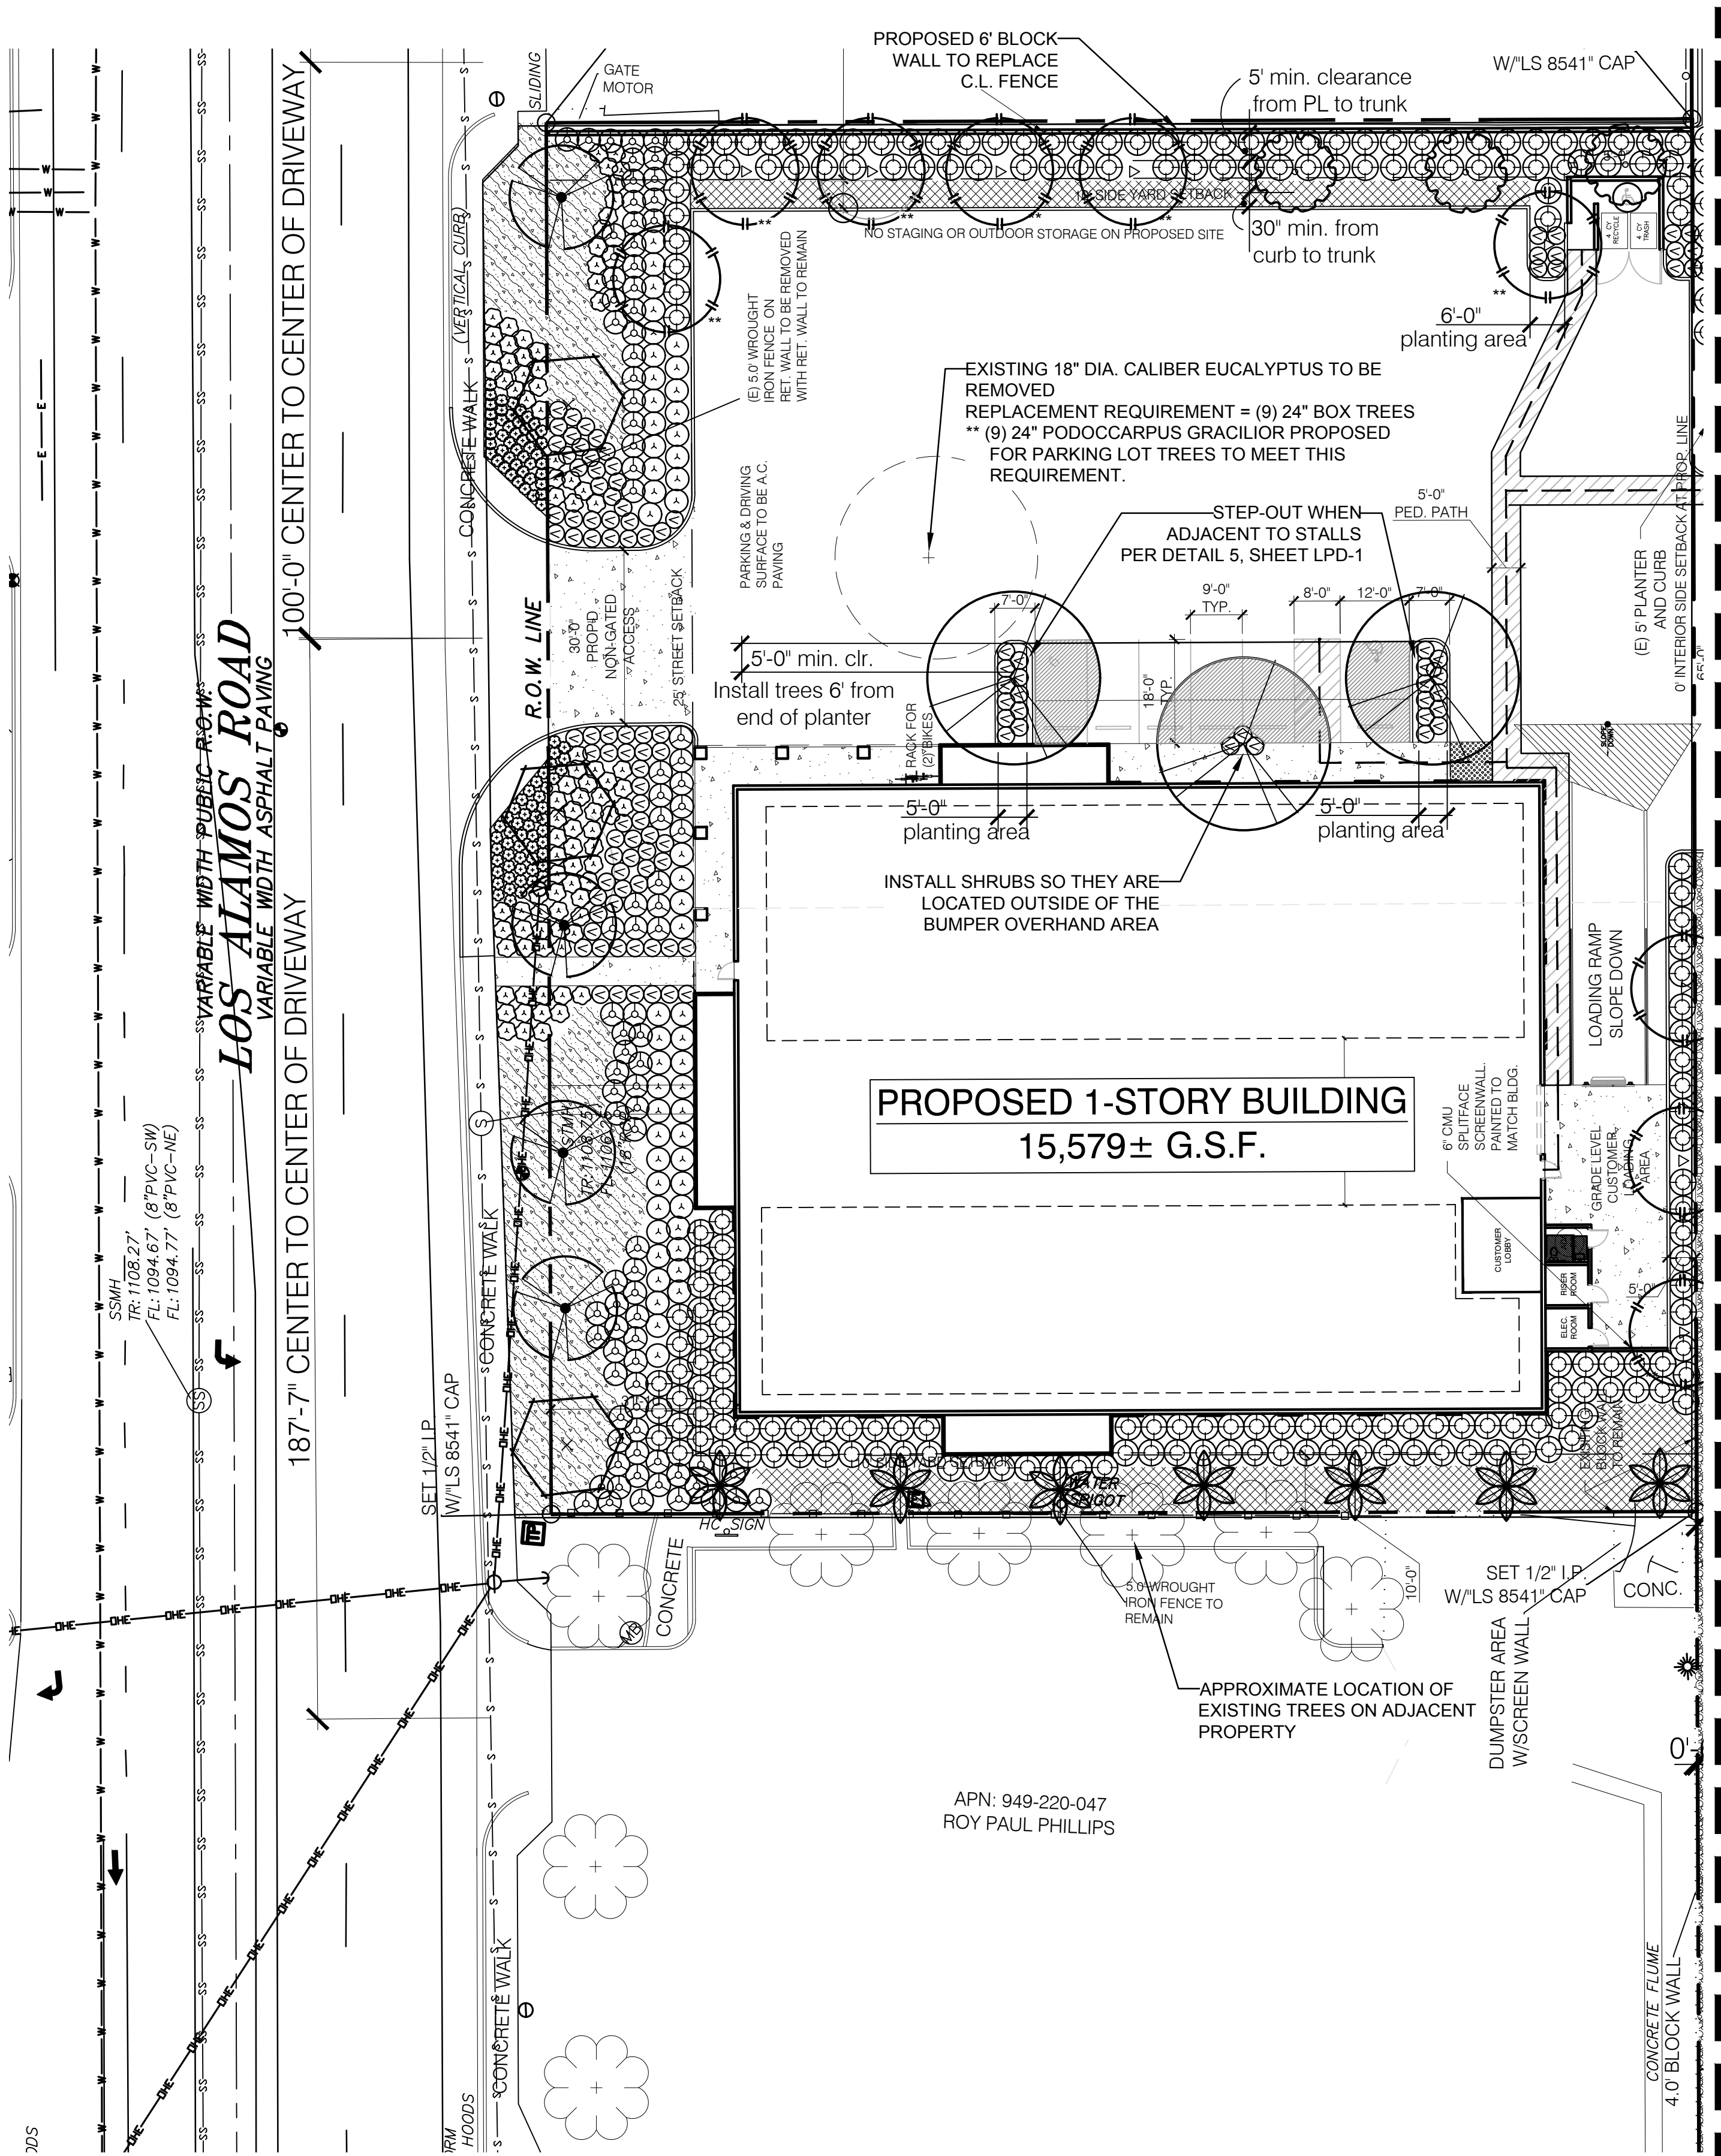

MATCHLINE: SEE SHEET LP-3

MATCHLINE: SEE SHEET LP-2

PLANT SCHEDULE NEW LANDSCAPE AREA LP-1

TREES	BOTANICAL / COMMON NAME	SIZE	WUCOLS	QTY
	MELALEUCA QUINQUENERVIA CAJEPUT TREE	24"BOX	M	3
	OLEA EUROPAEA 'WILSONII' FRUITLESS WILSON OLIVE	24"BOX	M	3
	PISTACIA CHINENSIS CHINESE PISTACHE	24"BOX	M	4
	** PODOCARPUS GRACILIOR FERN PINE	24"BOX	M	9
	SYAGRUS ROMANZOFFIANA QUEEN PALM	24"BOX	M	7
	ULMUS PARVIFOLIA 'DRAKE' DRAKE LACEBARK ELM	24" BOX	L	3
SHRUBS	BOTANICAL / COMMON NAME	SIZE	WUCOLS	QTY
	ALOE STRIATA CORAL ALOE	5 GAL	L	100
	ANIGOZANTHOS FLAVIDUS KANGAROO PAW	1 GAL	L	132
	DIANELLA T REVOLUTA FLAX LILY	5 GAL	L	115
	LEONOTIS LEONURUS LION'S TAIL	5 GAL	L	44
	LEUCOPHYLLUM FRUTESCENS 'GREEN CLOUD' TM GREEN CLOUD TEXAS RANGER	5 GAL	L	139
	WESTRINGIA FRUTICOSA 'MORNING LIGHT' MORNING LIGHT COAST ROSEMARY	5 GAL	L	85
GROUND COVERS	BOTANICAL / COMMON NAME	SIZE	WUCOLS	QTY
	LANTANA X 'NEW GOLD' NEW GOLD LANTANA	1 GAL @ 5' O.C.	L	1,925 SF
	MYOPORUM PARVIFOLIUM TRAILING MYOPORUM	1 GAL @ 5' O.C.	L	1,768 SF

REFER TO TITLE SHEET FOR PLANTING NOTES

EXISTING SITE LANDSCAPING


Site Area - Parcel 1	141,243 sf
Total shrub area	23,630 sf
Existing shrub area percentage	(17%)

PROPOSED LANDSCAPING

Site Area - Parcels 3 & 4	48,128 sf
Overall shrub area	11,625 sf
Landscape within right-of-way	1,595 sf
Landscape within bumper overhang	20 sf
Proposed shrub area percentage	(27%)

PARKING LOT SHADING

Parking area	1,025 sf
Shaded area	679 sf
Shaded parking area percentage	(66%)

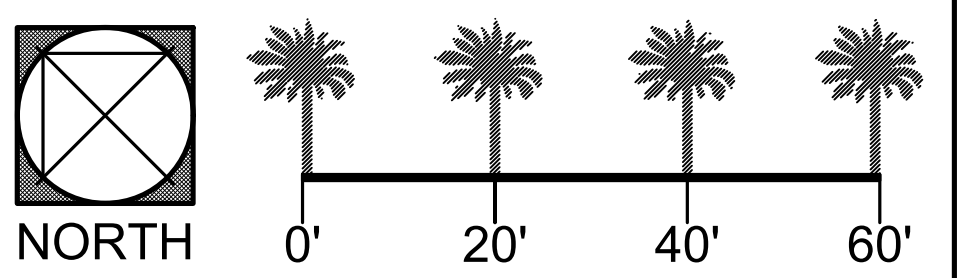


PREPARED FOR:
AMERCO REAL ESTATE COMPANY
2727 N. CENTRAL AVE. 9-N
PHOENIX, AZ. 85004

Underground Service Alert
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1-800-422-4133
TWO WORKING DAYS BEFORE YOU DIG

BENCH MARK DESCRIPTION: _____ LOCATION: _____ RECORDED: _____ ELEVATION: _____ DATUM: _____

"AS BUILT"
THE RECEIPT OF AS-BUILT PLANS AND CITY'S ACCEPTANCE THEREOF DOES NOT ABSOLVE THE ENGINEER OF WORK OF ANY RESPONSIBILITY FOR THE PROJECT DESIGN.
ENGINEER OF WORK _____ DATE _____
RCE NO. _____ EXPIRATION DATE _____

APPROVED FOR SIGNATURE
PLAN CHECK ENGR. NAME TYPED _____ DATE _____
PLAN CHECK FIRM RCE NO. _____

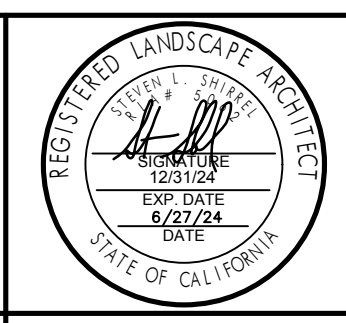


bmla
LANDSCAPE ARCHITECTURE
310 NORTH JOY STREET | CORONA, CA 92679
T: 951.737.1124 | F: 951.737.6551

AS NOTED PREPARED BY _____ DATE _____
VERTICAL STEVE SHIRREL
AS NOTED CA LIC NO. 5062 EXP. DATE 12/31/24

DATE	INITIAL	REVISION DESCRIPTION	SHT. NO.	DATE	INITIAL

SHEET 7	CITY OF MURRIETA	SHEETS 11
NEW PLANTING PLAN		
U-HAUL OF MURRIETA MURRIETA, CA 92562		
APPROVED _____ DATE _____	DIRECTOR OF PUBLIC WORKS / CITY ENGINEER RCE	
DWN BY: _____	PROJECT NO. _____	DRAWING NO. LP-1

MATCHLINE: SEE SHEET LP-3

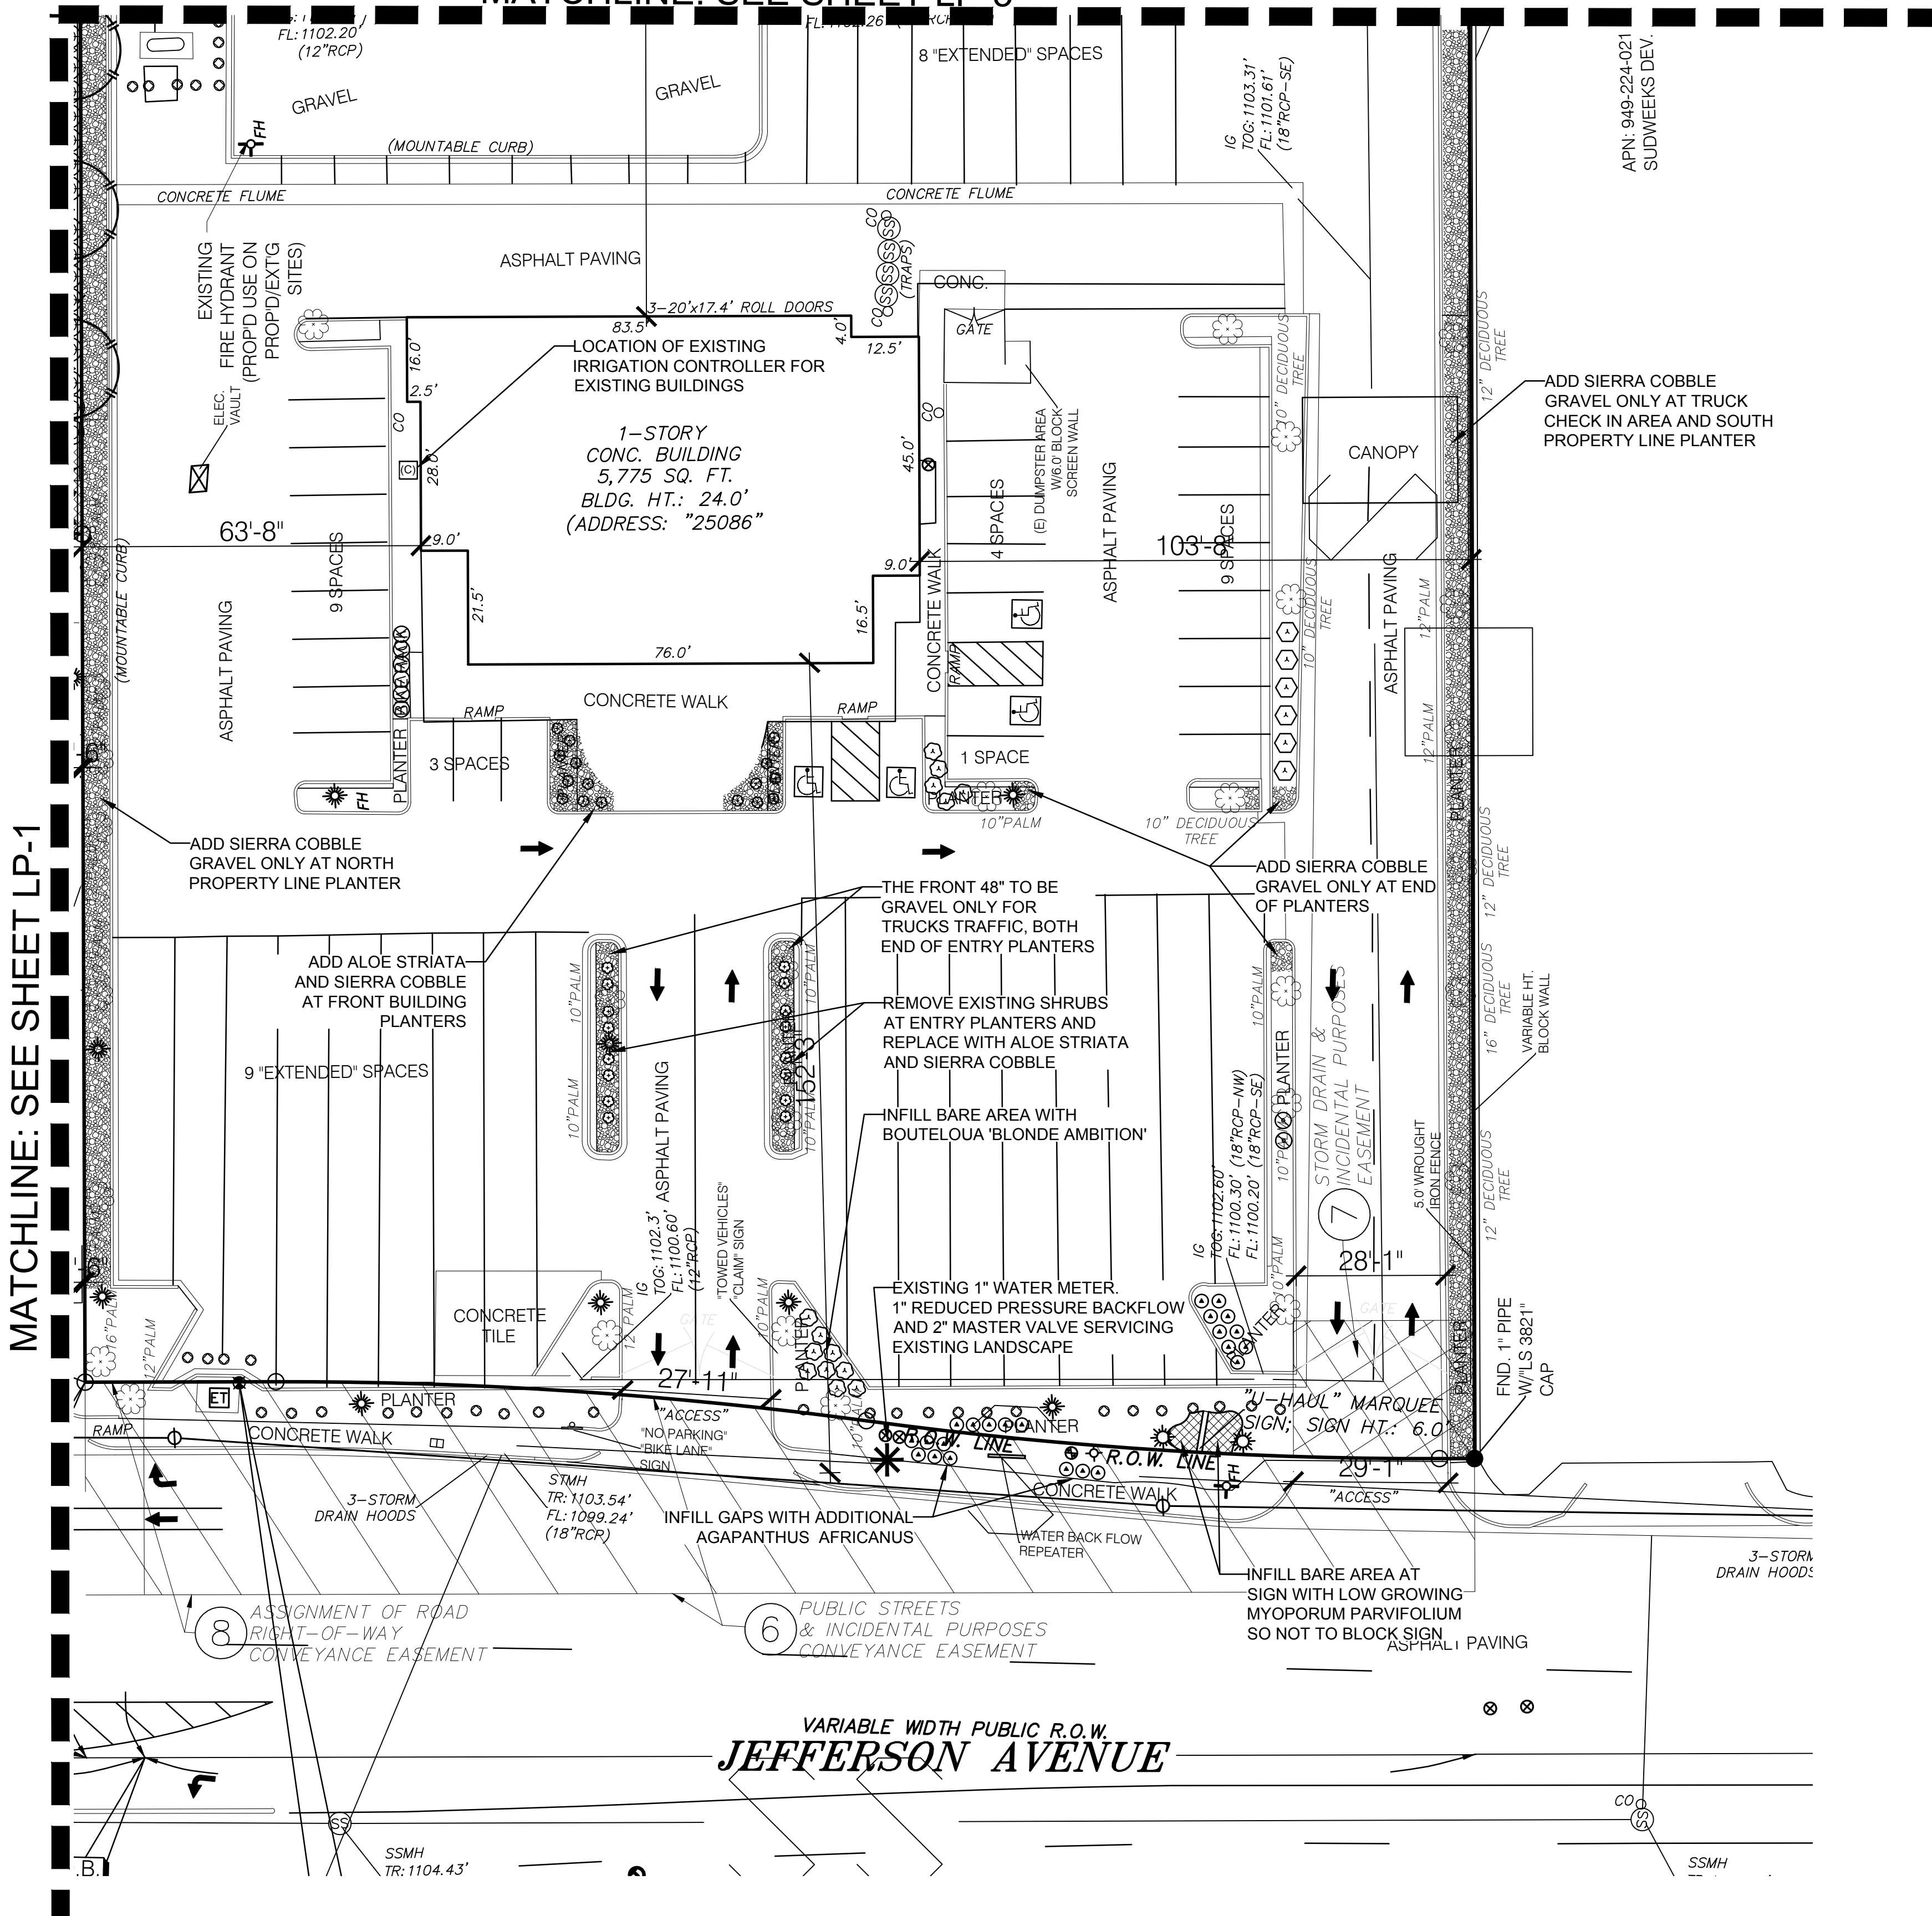


MATCHLINE: SEE SHEET LP-1

EXISTING LANDSCAPE ADDITIONS LP-2 & LP-3

SYMBOL	BOTANICAL / COMMON NAME	SIZE	WUCOLS	QTY
SHRUBS				
▲	AGAPANTHUS AFRICANUS AFRICAN LILY	1 GAL	M	23
+	ALOE STRIATA CORAL ALOE	1 GAL	L	32
⊖	ANIGOZANTHOS FLAVIDUS KANGAROO PAW	1 GAL	L	14
⊙	DIANELLA T REVOLUTA FLAX LILY	5 GAL	L	6
⊗	DIETES VEGETA AFRICAN IRIS	1 GAL	M	2
⊕	HESPERALOE PARVIFLORA RED YUCCA	1 GAL	L	6
⊗	LEUCOPHYLLUM FRUTESCENS 'GREEN CLOUD' GREEN CLOUD TEXAS RANGER	5 GAL	L	7
GROUND COVERS				
⊞	3-5" SIERRA COBBLE	NONE		3,156 SF
⊞	MYOPORUM PARVIFOLIUM TRAILING MYOPORUM	1 GAL @ 5' O.C.	L	399 SF

REFER TO TITLE SHEET FOR PLANTING NOTES

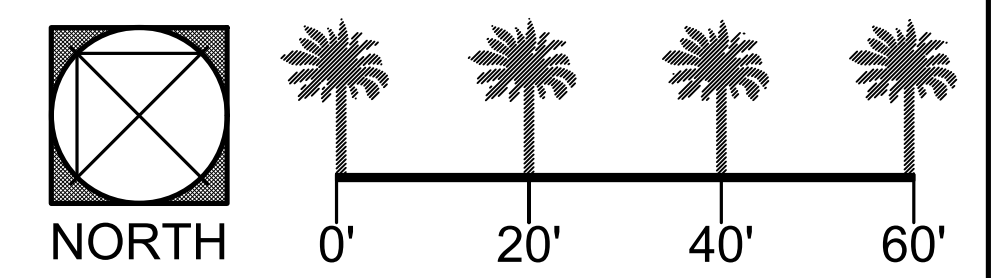


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PHOENIX, AZ. 85004

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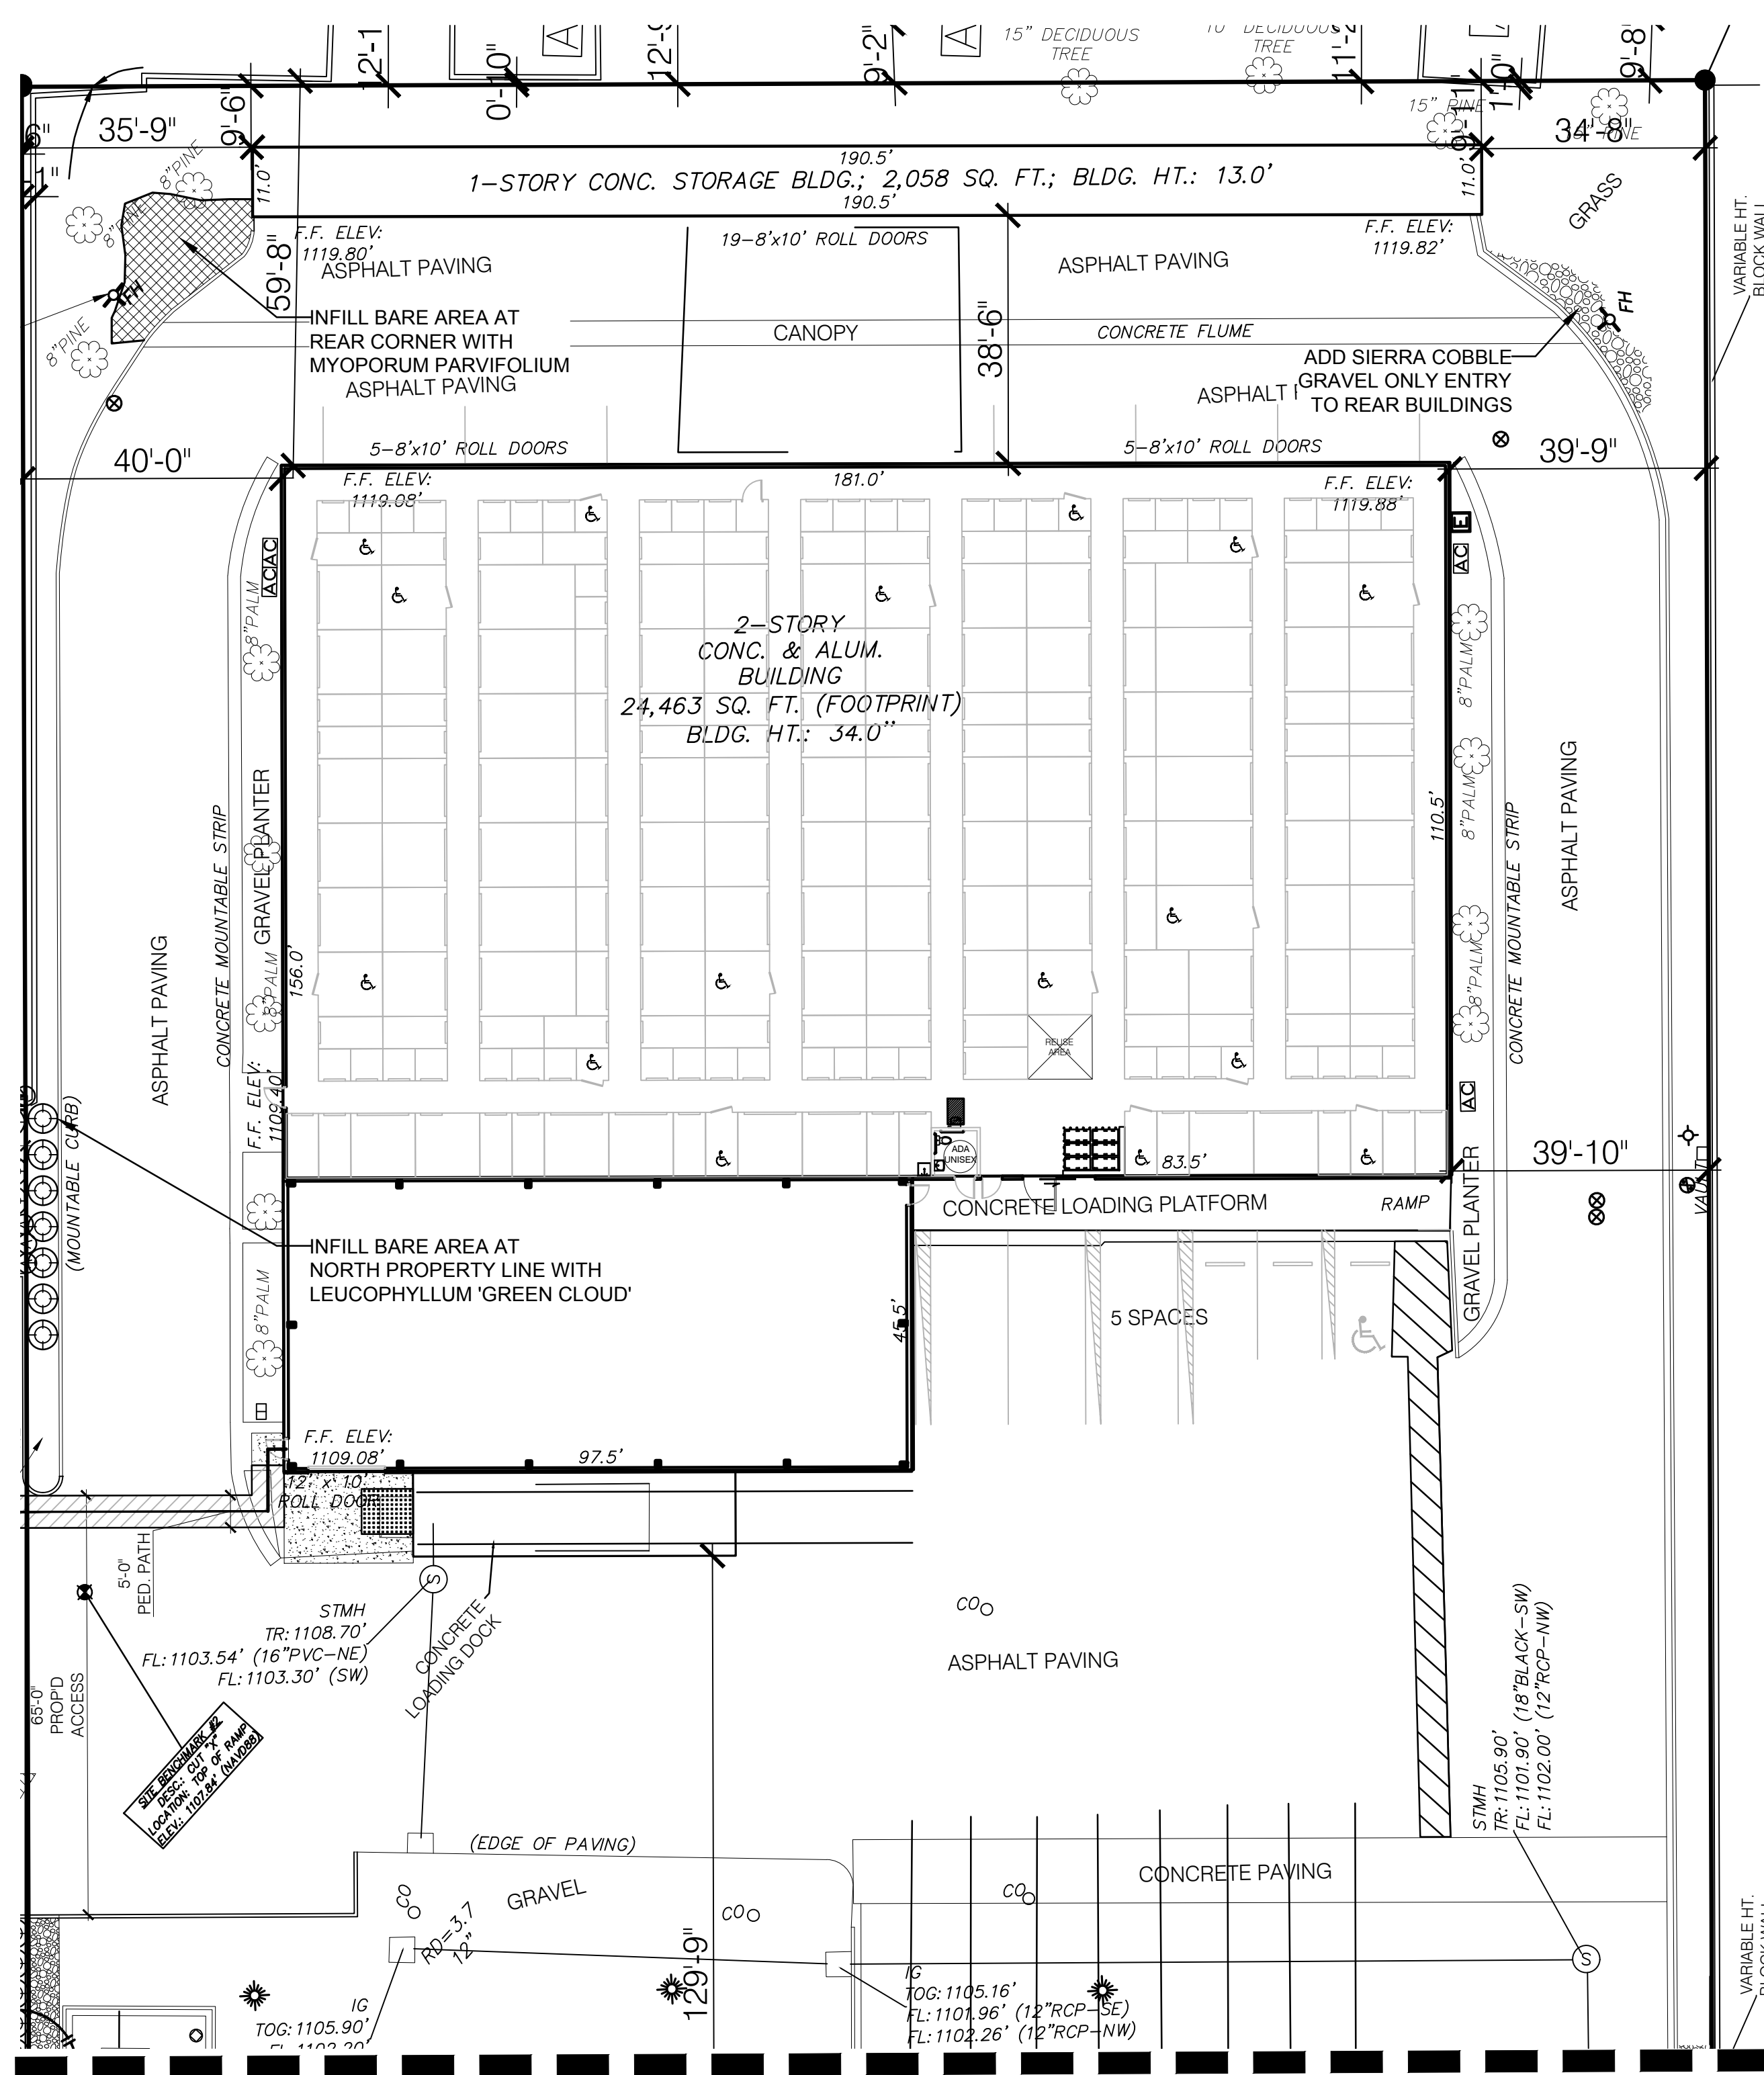
bmla
LANDSCAPE ARCHITECTURE
310 NORTH JOY STREET | CORONA, CA 92679
T: 951.737.1124 | F: 951.737.6551

AS NOTED PREPARED BY: _____ DATE: _____
VERTICAL STEVE SHIRREL
AS NOTED CA LIC NO. 5062 EXP. DATE 12/31/24

DATE	INITIAL	REVISION DESCRIPTION	SHT. NO.	DATE	INITIAL

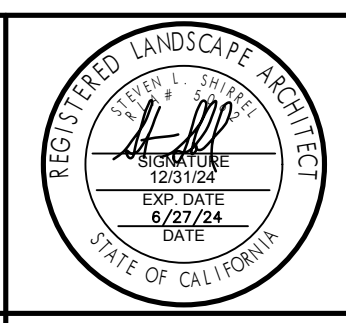SHEET 8 CITY OF MURRIETA SHEETS 11
EXISTING PLANTING ADDITIONS
U-HAUL OF MURRIETA
MURRIETA, CA 92562
APPROVED: _____ DATE: _____
DIRECTOR OF PUBLIC WORKS / CITY ENGINEER RCE
DWN BY: _____ PROJECT NO. _____ DRAWING NO. LP-2
CHKD BY: _____
FIELD BK: _____

MATCHLINE: SEE SHEET LP-1




MATCHLINE: SEE SHEET LP-2


EXISTING LANDSCAPE ADDITIONS LP-2 & LP-3

SYMBOL	BOTANICAL / COMMON NAME	SIZE	WUCOLS	QTY
SHRUBS				
▲	AGANTHUS AFRICANUS AFRICAN LILY	1 GAL	M	23
+	ALOE STRIATA CORAL ALOE	1 GAL	L	32
⋈	ANIGOZANTHOS FLAVIDUS KANGAROO PAW	1 GAL	L	14
∩	DIANELLA T REVOLUTA FLAX LILY	5 GAL	L	6
⊗	DIETES VEGETA AFRICAN IRIS	1 GAL	M	2
⬠	HESPERALOE PARVIFLORA RED YUCCA	1 GAL	L	6
⊕	LEUCOPHYLLUM FRUTESCENS 'GREEN CLOUD' GREEN CLOUD TEXAS RANGER	5 GAL	L	7
GROUND COVERS				
⊠	3-5" SIERRA COBBLE	NONE		3,156 SF
⊞	MYOPORUM PARVIFOLIUM TRAILING MYOPORUM	1 GAL @ 5' O.C.	L	399 SF

REFER TO TITLE SHEET FOR PLANTING NOTES

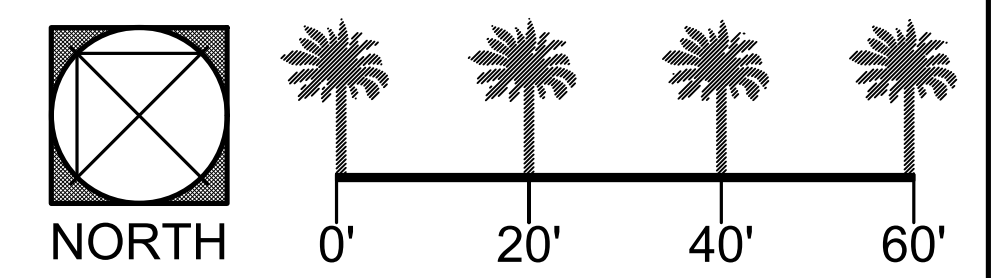


AMERCO
REAL ESTATE COMPANY
2727 N. CENTRAL AVE. 9-N
PHOENIX, AZ. 85004

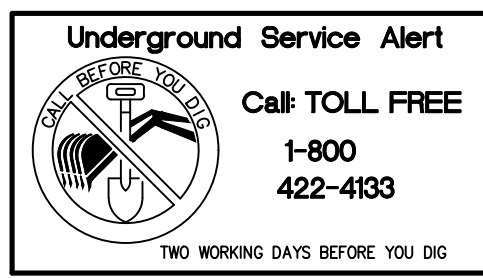

BENCH MARK
DESCRIPTION: _____
LOCATION: _____
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RCE NO. _____ EXPIRATION DATE: _____

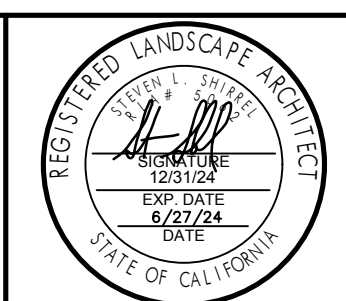

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LANDSCAPE ARCHITECTURE
310 NORTH JOY STREET | CORONA, CA 92879
T: 951.737.1124 | F: 951.737.6561

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PLAN CHECK FIRM RCE NO. _____



AS NOTED PREPARED BY _____ DATE _____
VERTICAL STEVE SHIRREL
AS NOTED CA LIC NO. 5062 EXP. DATE 12/31/24

DATE	INITIAL	REVISION DESCRIPTION	SHT. NO.	DATE	INITIAL	CITY APPROVAL

SHEET 9 CITY OF MURRIETA SHEETS 11

EXISTING PLANTING ADDITIONS
U-HAUL OF MURRIETA
MURRIETA, CA 92562

APPROVED _____ DATE _____
DIRECTOR OF PUBLIC WORKS / CITY ENGINEER RCE
DWN BY: _____ PROJECT NO. _____ DRAWING NO. LP-3
CHKD BY: _____
FIELD BK: _____

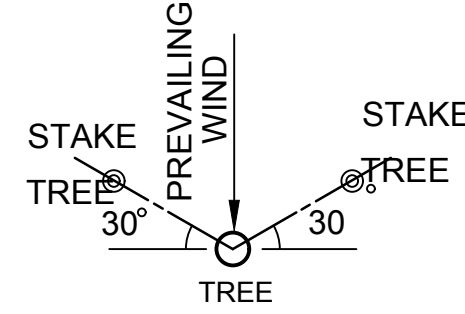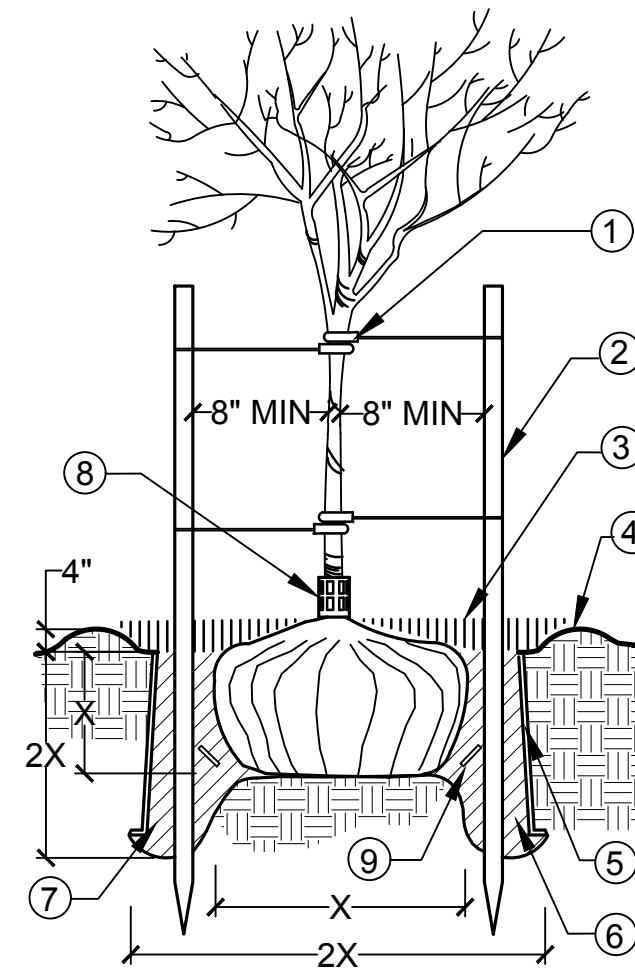

NOTES:



- A. AFTER SETTLEMENT, THE TOP OF ROOTBALL & ROOT BARRIER BOX IS TO BE FLUSH WITH FINISH GRADE.
- B. TOP OF ROOTBALL IS TO BE PLACED AT 1-1/2" ABOVE FINISH GRADE. THE FINISH GRADE IS TO BE LEVEL WITH TOP OF CONCRETE CURB OR SIDEWALK.

LEGEND:

1. RUBBER/VINYL "CLINCH TIE" OR APPROVED EQUAL NAILED TO STAKE.
2. LODGE POLE PINE TREE STAKES TREATED W/ COPPER NAP THANET. 2" DIA. X 10' LONG.
3. 4" THICK SHREDDED BARK MULCH
4. 4" BERM FOR TEMP WATERING UNTIL SEEDING.
5. INSTALL DEEP ROOT BARRIER PANEL. MODEL NUMBER UB 24-2'X8' AS MANUFACTURED BY DEEP ROOT CORP. OR SHAWTOWN IND. OR APPROVED EQUAL.
6. BACKFILL MIX - NATIVE SOIL
7. PLANT PIT: TWICE THE WIDTH OF ROOTBALL
8. VENTILATED ARBOR GUARD IN TURF
9. FERTILIZER TABLET

LEGEND:

1. ROOTBALL - DO NOT COMPACT ROOTBALL SOIL. ALLOW ROOTBALL TO SETTLE TO FINISHED GRADE.
2. FINISH GRADE.
3. 3" SHREDDED BARK MULCH.
4. 3" BERM TIGHTLY COMPACTED IN PLACE TO FORM WATERING BASIN.
5. NATIVE SOIL.
6. GROW POWER PLANT TABS PER MANUFACTURERS RECOMMENDATIONS.
7. PREPARED SOIL MIX. PLANT PIT TO BE 1 1/2 TIMES THE WIDTH OF THE ROOTBALL.
8. SHRUB TRUNK.

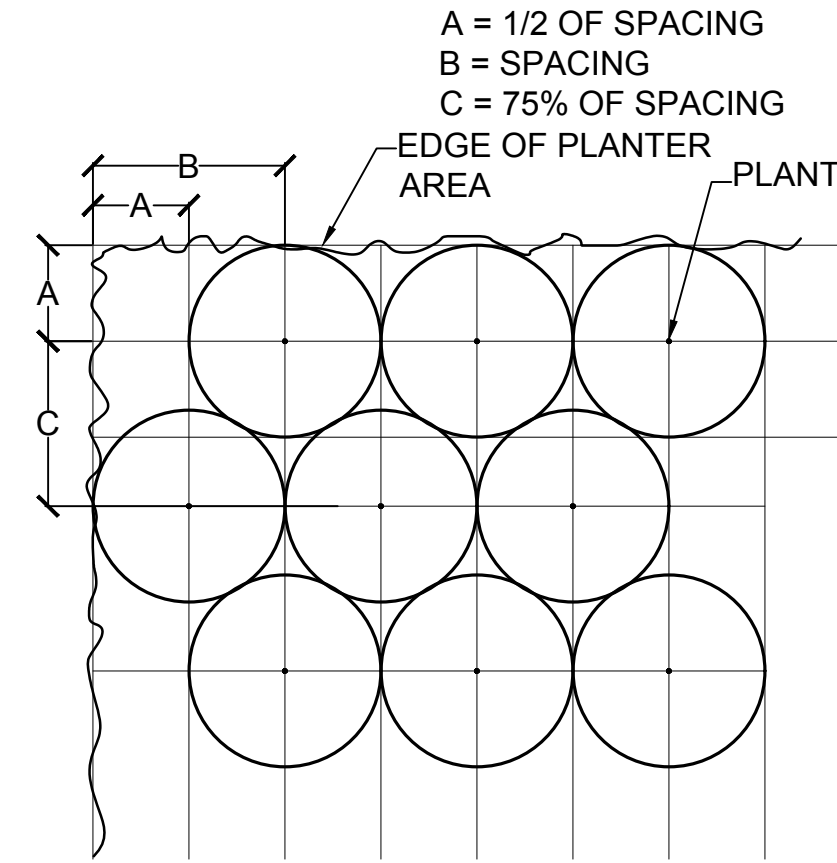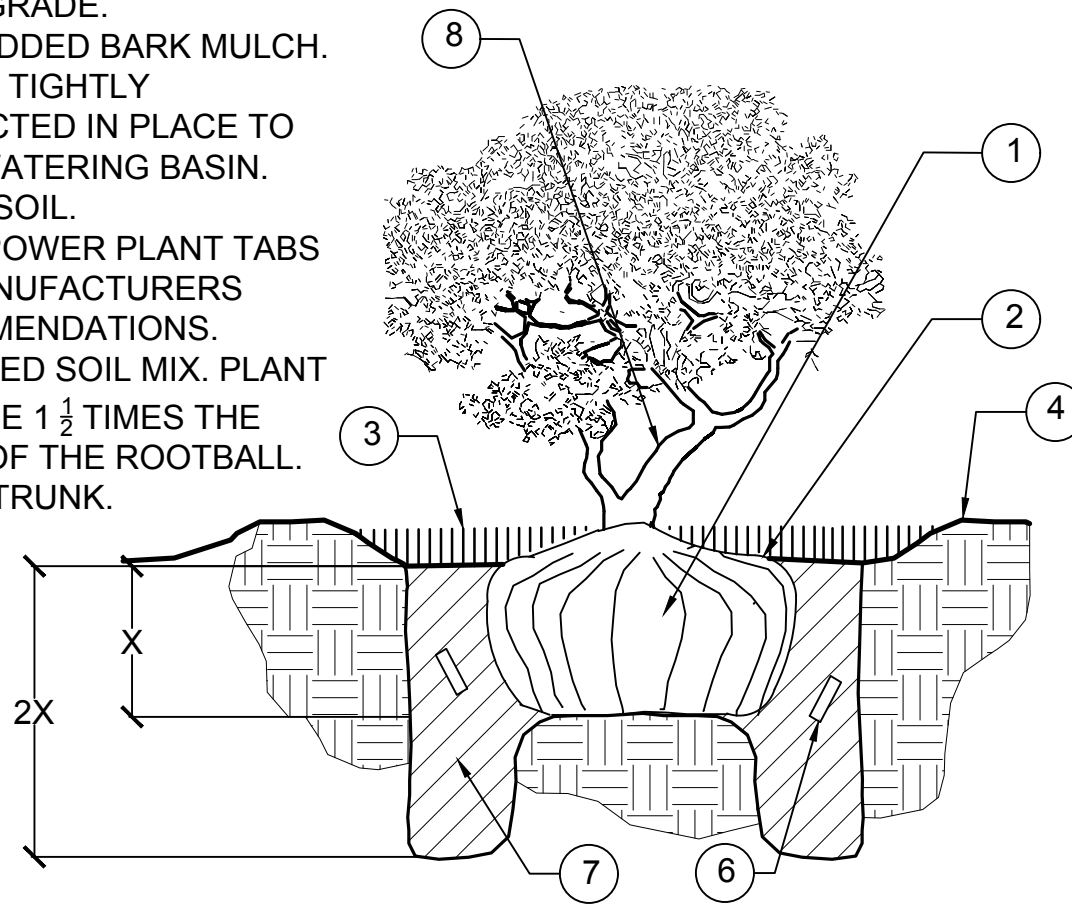

1 TREE PLANTING DETAIL
1/2" = 1'-0"

2 SHRUB PLANTING DETAIL
1" = 1'-0"

3 GROUNDCOVER DETAIL
1" = 1'-0"

Linear Application of DeepRoot Tree Root Barriers at Time of Installing Concrete Sidewalks and Curbs

TYPICAL SECTION OF CURB AND GUTTER WITH DEEPROOT TREE ROOT BARRIER INSET INTO CONCRETE. BARRIER INSTALLED IN A TRENCH IN SUBGRADE WHICH IS THEN COMPACTED. BARRIER IS SET SO THAT TOP EDGE WILL BE 2" (5CM) BELOW FINISH GRADE OF CURB, AND SET FLUSH WITH EDGE OF CURB. BARRIER RIBS FACE TOWARD TREE ROOTS.

INSTALLATION SEQUENCE:

1. Prepare base and subgrade
2. Trench to appropriate depth for installation of root barrier so that top of barrier is 2" (5cm) below finish grade of top of curb.
3. Place root barrier in trench, vertical ribs must face toward tree roots.
4. Backfill and compact to requirements.
5. Place form material against barrier (It may be nailed from the outside of the form)

TYPICAL SECTION OF CURB, GUTTER AND SIDEWALK WITH DEEPROOT TREE ROOT BARRIER INSET INTO CONCRETE



BARRIER INSTALLED IN A TRENCH IN SUBGRADE WHICH IS THEN COMPACTED. BARRIER IS SET SO THAT TOP EDGE WILL BE 2" (5CM) ABOVE COMPACTED BASE (or halfway between base and finish grade of SW). BARRIER RIBS FACE TOWARD TREE ROOTS.

NOTE:
USE 18" DEEP ON SIDEWALK SIDE AND 24" DEEP ON CURB SIDE.



INSTALLATION SEQUENCE:

1. Prepare base and subgrade
2. Trench to appropriate depth for installation of root barrier so that top of barrier is 2" (5cm) below finish grade of top of sidewalk (or halfway between top of compacted base and finish grade of SW)
3. Place root barrier in trench, vertical ribs must face toward tree roots.
4. Backfill and compact to requirements.
5. Place form material against barrier (It may be nailed from the outside of the form)

IMPORTANT NOTE: Tree location must align with "as-built" center of barrier.

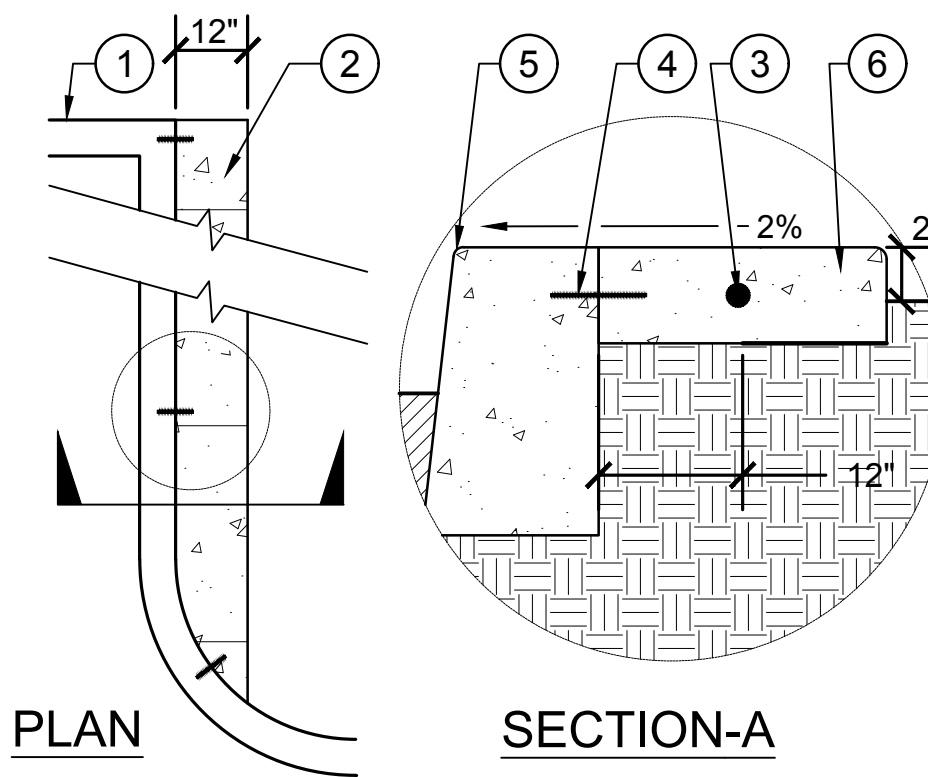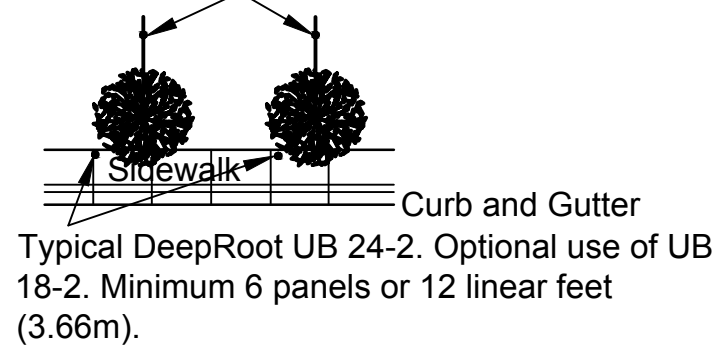

1. CONCRETE CURB PER CIVIL ENGINEER'S PLAN
2. 4" THICK CONCRETE STEP OUT STRIP
3. #3 REBAR CONTINUOUS CENTER
4. 6" LONG #3 REBAR DOWELS AT 3 PLACES SPACED EVENLY
5. 1/2" RADIUS TOOL JOINT/EDGES
6. FINISH GRADE

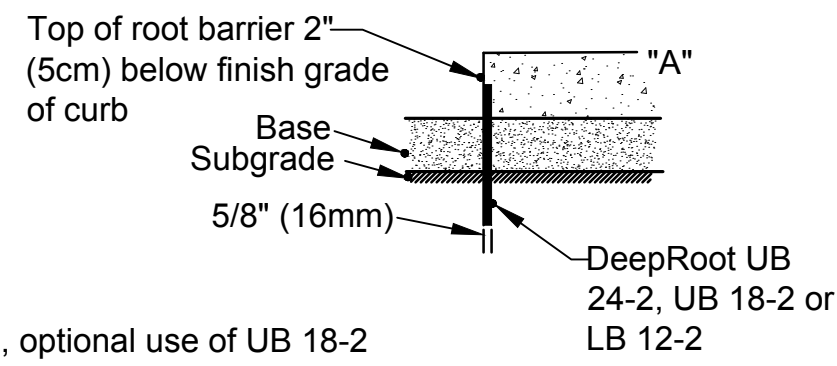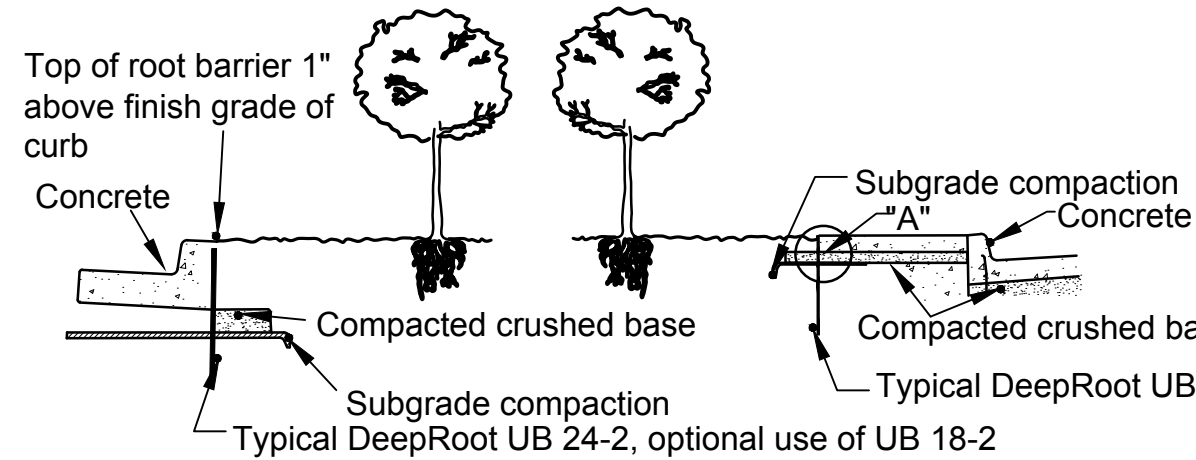

4 ROOT BARRIER
1/2" = 1'-0"

5 CONCRETE STEPOUT
3/8" = 1'-0"

PREPARED FOR:



BENCH MARK

DESCRIPTION: _____

LOCATION: _____


RECORDED: _____

ELEVATION: _____ DATUM: _____

APPROVED FOR SIGNATURE

PLAN CHECK ENGR. NAME TYPED _____ DATE _____

PLAN CHECK FIRM RCE NO. _____

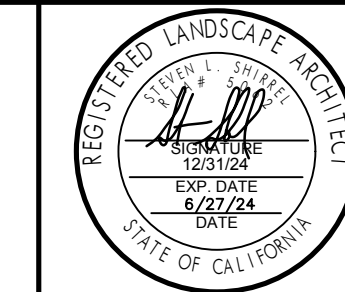

PREPARED BY: STEVE SHIRREL

DATE: 12/31/24

DATE	INITIAL	REVISION DESCRIPTION	SHT. NO.	DATE	INITIAL

SHEET 10 CITY OF MURRIETA SHEETS 11

PLANTING DETAILS

U-HAUL OF MURRIETA MURRIETA, CA 92562

APPROVED: _____ DATE _____

DIRECTOR OF PUBLIC WORKS / CITY ENGINEER RCE

DWN BY: _____ PROJECT NO. _____ DRAWING NO. LPD-1

SECTION 02800

PLANTING

PLANTING SPECIFICATIONS GENERAL

1. General Requirements
 - A. Permits: Contractor shall obtain and pay for any permits required.
 - B. All irrigation shall be completed, approved and under automatic operation for a minimum of 7 days prior to any planting.
2. Scope Of Work
 - A. The intent of the drawings and specifications is to indicate the processes required for the installation of a complete planting without additional cost in labor and material to the Owner.
3. Inspections
 - A. Request for inspections must have 48 hour notice in advance.
 - B. Contractor must be on site for all inspections.
 - C. Any work not completed when inspector arrives which was requested for, shall be billed to the contractor at the current inspector's rate.
 - D. Any work completed without inspection or approval shall be removed, exposed or replaced at the cost of the contractor.
 - E. Contractor shall call for inspection for the following items:
 - I. Final grading
 - II. Weed-abatement Observation
 - III. Tree and shrub layout
 - IV. Tree and shrub planting pits
 - V. Finish grade prior to hydro-seeding
 - VI. Final Inspection
4. Submittals
 - A. All submittals shall be submitted within 15 days after receipt of executed contract
 - B. Contract shall submit the follow items but not limited to:
 - I. Plant material proof of purchase with listed nurseries and material sizes for approval
 - II. All soil amendments
 - III. Bark mulch
 - IV. Soil report
 - V. Labels for all herbicide and fertilizers used
 - VI. Clydro-seed mix

PLANTING SPECIFICATIONS MATERIALS

1. Plant Material
 - A. All plant material shall be the same as specified in the drawings.
 - B. Contractor shall tag one plant from each bundle or lot with the plant name in accordance with the recommendations of the American Association of Nurserymen.
 - C. All plant material shall be free of pest, plant diseases abrasions or any other objectable disfigurements.
 - D. Plant material must show vigorous habit of growth that is normal for that particular species.
2. Tree Stakes
 - A. Tree stakes shall be copper maphthanate, green color impregnated lodge pole pine.
 - B. Tree stake shall be 2" in diameter 10 feet long
 - C. Tree ties shall be V.I.T. cinch ties or approved equal four per tree typ.
 - D. Tree ties shall be attached to lodge poles with galvanized nails per detail.
3. Vine Ties
 - A. Vine ties shall be as specified in details
4. Herbicides
 - A. Contractor shall submit labels of all herbicides used prior to application for approval.
 - B. Contractor shall apply pre-emergent herbicide to all areas possible as recommended by a licensed pest control consultant.
5. Concrete Mow Curb
 - A. Concrete mow curb shall be 2500 PSI concrete and as specified in detail.
6. Redwood Header Board
 - A. Redwood header board shall be grade A fine redwood and as specified in detail.
7. Plant Tablets
 - A. Planting tablets shall be as specified in detail.
8. Soil Conditioners
 - A. All soil conditioner material shall be approved prior to ordering under this section.
 - B. Soil conditioners shall be based on soil report recommendations.

PLANTING SPECIFICATIONS EXECUTION

1. Installation
 - A. Contractor shall clean, remove, legally dispose of all grasses including rots and construction debris under this section.
 - B. Contractor shall be responsible for the protection and storage of all material for the project.
 - C. All grades shall be as indicated on the drawings and must be ±10%
2. Landscape Grading
 - A. The Contractor shall complete grading and filling as needed or remove additional dirt, rock and debris over 3/4 inch in diameter within the top 3 inches in all turf and planter areas less than 3:1.
 - B. Contractor shall bring all landscaped areas to finish grade.
 - C. Flow lines shall be established to existing curbs and/or sidewalks.
 - D. All landscape areas shall be slopes to provide positive drainage.
3. Soil Preparation
 - A. Contractor shall roto-till amendments into all turf and planter areas 3:1 or less throughout the first 6 inches.
 - B. The following application rate is for bidding purposed only and is per 1000 square feet of planting area.
 - I. 4 cubic yards of soil conditioner
 - II. 30 lbs. of commercial fertilizer approved by the Owner's representative.
 - III. 50 lbs. of agriculture grade gypsum
 - IV. 25 lbs. soil sulfur
 - C. Actual soil preparation shall be based on the soil report.
 - D. Soil samples shall be taken in the presence of the Owner's representative
 - E. Contractor shall submit soil samples to an approved laboratory testing facility
 - F. Contractor shall proved one (1) soil report for every 50,000 square feet.
 - G. Soil recommendations must be separated for turf, planter, slope and plant material back fill mix.
4. Weed-abatement
 - A. Weed-abatement shall not commence until complete irrigation system is under complete automatic irrigation and has been approved.
 - B. Upon completion of soil preparation the contractor shall complete the following:
 - I. Irrigate all area to be planted, sodded or seeded for a period of seven (7) days to germinate all weed seeds.
 - II. Cut watering and apply approved weed killer per manufacture's recommendations and allow adequate time to complete kill.
 - III. Repeat step one and two
 - IV. Obtain approval of completed weed-abatement prior to any planting. Trees may be planted prior to weed-abatement process with the approval of the Owner's representative in writing.
5. Layout
 - A. Contractor shall layout all tree and shrubs for approval from the Owner's representative prior to excavating and planting pits.
 - B. Contractor shall no willfully layout and planting material where obstructions exist. The contractor shall notify the engineer to obtain direction.
6. Planting
 - A. Planting shall be as shown in detail and as follows:
 - I. Excavate all planting pits to a diameter twice the size of container to be planted and 1 1/2 times the depth of container to be planted.
 - II. Contractor shall clarify the side of planting pits if auger is used with shovel of digging bar.
 - III. Plant material shall be placed in planting pit in a manner as not to disrupt the root ball and the crown shall be set aligned flush to grade.
 - IV. Provide 21 gram fertilizer tablets per detail.
 - V. Backfill all plant material with approved backfill mix.
 - VI. Contractor shall provide 5 gram fertilizer tablets to all rooted cuttings.
7. Percolation Test
 - A. Contractor shall flood planting pits with water to test water penetration through the soil, if no penetration occurs the contractor shall auger 6 inches in diameter and 36 inches long and backfill with pea gravel, repeat water test bad if water still does not penetrate the contractor shall notify the Owner's representative prior to planting.
8. Sodded Turf
 - A. All sodded areas shall be semi dwarf fescue unless otherwise noted.
 - B. Contractor shall evenly rake all sodded areas to level and remove all rocks 3/4 inch in diameter and larger.
 - C. Contractor shall spread 16-20-0 commercial fertilizer to all sodded areas.
 - D. Contractor shall lay sod immediately upon arrival.
 - E. Sod must be laid along a straight line staggering each row like laying bricks and must be butted tightly together preventing any air pockets. Do not overlap edges.
 - F. Sod shall be cut with a sharp knife and never pulled apart.
 - G. Sod must be rolled immediately after sod is installed.
 - H. Sod must be watered thoroughly to a depth of 12 inches.
 - I. Contractor shall monitor watering to prevent browning and fungus.
 - J. Contractor shall take every measure possible to protect sod by providing temporary fencing if necessary at no additional cost.
9. Turf Hydro-seeding
 - A. Hydro-seeding seed mix shall be as indicated on the drawings.
 - B. Contractor shall evenly rake all sodded areas to level and remove all rocks 3/4 inch in diameter and larger.
 - C. Hydrido-mix slurry shall be as follows:

I. Seed	as specified
II. Fiber	2,000 lbs. per acre
III. M-Binder	100 lbs. acre
IV. Water	3,000 gal per acre or as required
V. Fertilizer/ Soil Conditioner	1,100 lbs. per acre

- D. Contractor shall monitor watering to prevent browning and fungus.
- E. Contractor shall take every measure possible to protect sod by providing temporary fencing if necessary at no additional cost.
- F. Hydro-mulch slurry shall be applied under high pressure evenly and provide a uniform coat an all areas specified.
- G. Overspray shall be removed immediately from sidewalks, walls or any structures.
- H. Contractor shall provide 98 percent germination to all hydro-seeded areas prior to turn over.
10. Root Barriers
 - A. Root barrier shall be "Deep Root" control barrier panels # UB 24-2 or approved equal. No cylinder root barriers shall be approved.
 - B. Root barriers shall be install for all trees planted within 5 feet of any hardscaping.
 - C. Contractor shall install root barriers per detail.
11. Jute Netting
 - A. Jute netting shall be uniform plain weave, flame-retardant mesh. Geo- jute, smolder resistant or approved equal. The mesh shall be green in color.
 - B. Jute shall be 48 inches wide with a weight of .97 pounds per lineary yard.
12. Grades
 - A. Prior to commencing any work the contractor shall carefully check all grades and verify that after all irrigation work and soil preparation completed, all grades will be per specified depth as per the landscape contractor's scope of work with a ± 1/10.
13. Guarantee
 - A. All trees 15 gallon and larger the contractor shall guarantee for a period of one year.
 - B. All trees smaller than 15 gallon and all other plant material shall be guaranteed for a period of 90 days.
 - C. All plant material that is dead or dying or as directed by the engineer within the guarantee period shall be replaced at the cost of the contractor with 7 days of written notice.
 - D. All replacement plant material shall be exact as specified in species and size. No substitutions shall be allowed unless written approval from the engineer is obtained.

- END OF SECTION -

SECTION 02900

MAINTENANCE SPECIFICATIONS GENERAL

1. Maintenance Duration
 - A. Contractor shall maintain entire project within the contractor's scope of work until final approval for all work has been obtained to start the 90 calendar day maintenance at the contractor's expense.
 - B. Contractor shall maintain all landscaped areas for a period o f90 calendar days unless otherwise noted.
2. Turf Maintenance
 - A. Contractor shall mow weekly or more if needed all turf areas to a height between 3/4 inch and 21/2 inch depending on variety of turf.
 - B. Contractor shall edge a turf areas a biweekly or more if needed.
 - C. All clippings must be removed from sidewalks or adjacent areas.
 - D. Contractor shall remove all excess clipping from turf areas.
 - E. Contractor shall monitor watering to all turf areas and provide sufficient moisture levels to all turf area.
3. Tree and Shrub Maintenance
 - A. Contractor shall remove any dead growth on all trees and shrubs as needed.
 - B. No stripping of lower branches from any tree or shrub unless directed by the engineer.
 - C. Trees and shrubs shall be pruned as directed by the engineer.
 - D. No topping of any tree is allowed unless directed by the engineer.
 - E. Contractor shall remove tree stakes when stakes are no longer needed.
4. Weed Control
 - A. All tree and shrub basins and all areas must be weed free.
 - B. Contractor shall apply pre-emergent herbicide where possible to prevent weeds as directed by a licensed pest control consultant.
 - C. Contractor shall remove all weed from site manually or chemically
5. Rodent Control
 - A. Contractor shall be responsible for maintaining a rodent free project.
 - B. All measures to eradicate rodents must be as directed by a licensed pest control consultant.
 - C. Contractor shall repair/replace all damaged caused by rodents under this section.
6. Fertilization
 - A. Contractor shall fertilize turf, slope and planter areas every 30 calendar days with approved fertilizer at the manufacture's recommended application rate.
 - B. Approved fertilizers are 15-15-15, 16-6-8 and 21-7-14
7. Maintenance General
 - A. Edge groundcover as needed to maintain no growth over sidewalks, around tree and shrub basins or up walls or fences.
 - B. Remove all trash weekly
 - C. Test complete irrigation system biweekly.
8. Clean-Up
 - A. Clean up shall take place on a daily basis, after each portion of work has been completed and as directed by the Owner's representative. The contractor shall legally remove from site any trash or material from his scope of work
9. Final Approval
 - A. All landscaped shall be inspected in it's entirety by the Owner's representative upon completion of 90 calendar day maintenance and have project turn over approved in writing.
 - B. Contractor shall provide all charts, record drawings, turn over items etc. prior to final turn over.

- END OF SECTION -

PREPARED FOR:



BENCH MARK

DESCRIPTION: _____

LOCATION: _____

RECORDED: _____

ELEVATION: _____ DATUM: _____

"AS BUILT"

THE RECEIPT OF AS-BUILT PLANS AND CITY'S ACCEPTANCE THEREOF DOES NOT ABSOLVE THE ENGINEER OF WORK OF ANY RESPONSIBILITY FOR THE PROJECT DESIGN.

ENGINEER OF WORK: _____ DATE: _____

RCE NO. _____ EXPIRATION DATE _____


APPROVED FOR SIGNATURE

DATE _____

PLAN CHECK ENGR. NAME TYPED _____ DATE _____

PLAN CHECK FIRM _____

RCE NO. _____

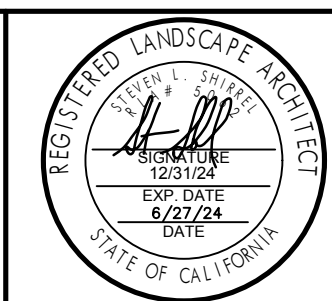

bmla
LANDSCAPE ARCHITECTURE

310 NORTH JOY STREET | CORONA, CA 92879
T: 951.737.1124 | F: 951.737.6551

AS NOTED _____

VERTICAL _____

AS NOTED _____

PREPARED BY _____ DATE _____

STEVE SHIRREL _____

CA LIC NO. 5062 EXP. DATE 12/31/24

DATE	INITIAL	REVISION	DESCRIPTION	SHT. NO.	DATE	INITIAL	CITY APPROVAL

SHEET 11	CITY OF MURRIETA	SHEETS 11
PLANTING SPECIFICATIONS		
U-HAUL OF MURRIETA MURRIETA, CA 92562		
APPROVED _____ DIRECTOR OF PUBLIC WORKS / CITY ENGINEER	DATE _____ RCE	
DWN BY: CHKD BY: FIELD BK:	PROJECT NO. _____	DRAWING NO. LPS-1



A&M ASSOCIATES, INC.
2727 N. CENTRAL AVENUE
PHOENIX, ARIZONA 85004
P: 602.263.6841



Preliminary Proposal

SHEET 01

Development Services
Department
Planning Division
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Received on: 08/09/2024
Case #:



AWNINGS, ARCADES AND WALL RECESSES USED TO PROVIDE FORM AND MASSING.

ARTICULATION PROVIDED BY CHANGES IN DEPTH AND COLOR ON ALL ELEVATIONS.

BUILDING STEP BACKS AND MASSING USED TO BREAK UP BUILDING PLANES AND PROVIDE COMPATIBILITY WITH THE SURROUNDING ARCHITECTURE

SPANDREL WINDOW GLAZING PROVIDES ADDITIONAL FENESTRATION




A&M ASSOCIATES, INC.
2727 N. CENTRAL AVENUE
PHOENIX, ARIZONA 85004
P: 602.263.6841



Northwest Elevation
Composite Rendering


SHEET 02

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NORTH ELEVATION - BUILDING C

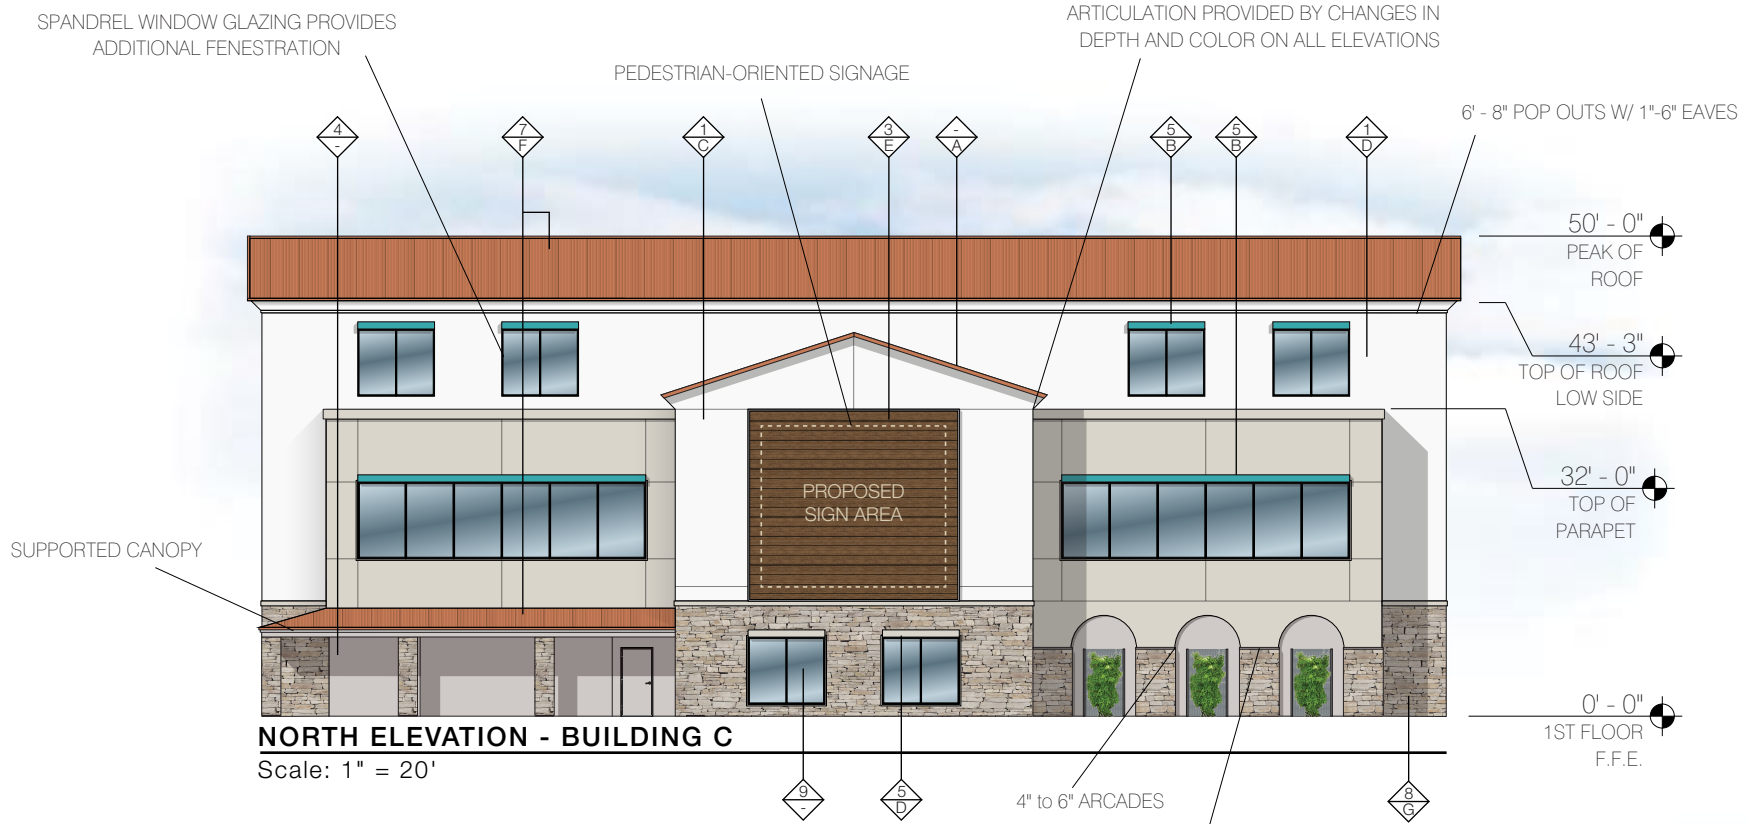Scale: 1" = 20'



EAST ELEVATION - BUILDING C

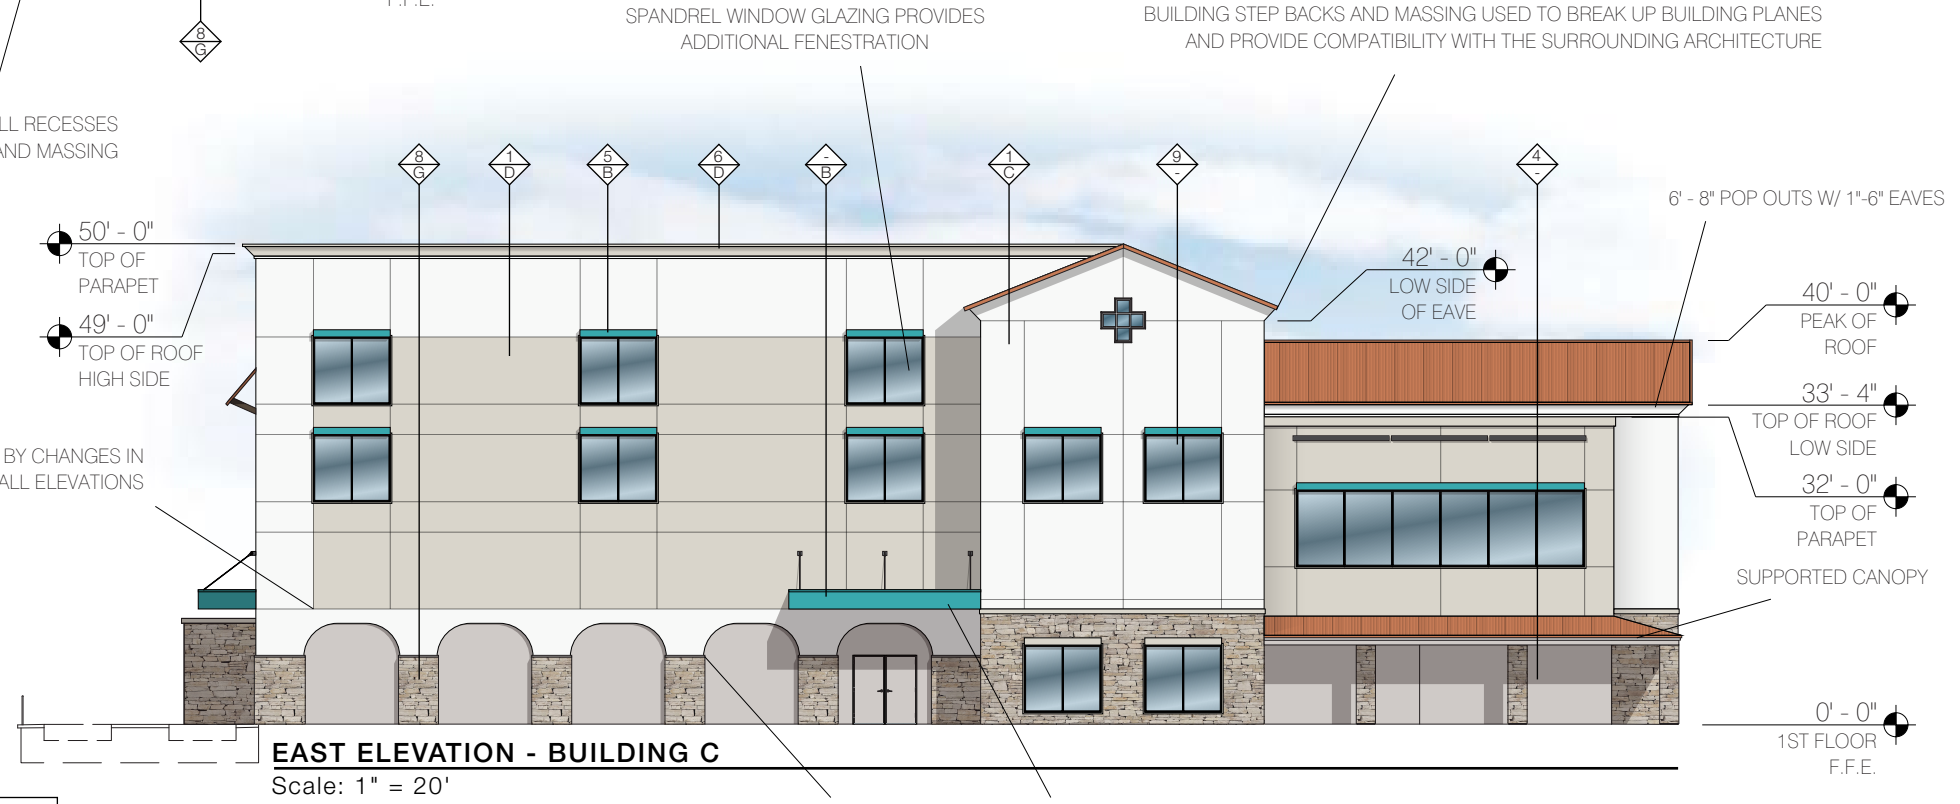Scale: 1" = 20'

GENERAL NOTES:

D1 - THE PROPOSED IMP USES FULL-WIDTH PANELS. **DO NOT CUT IMP** DUE TO PAINT VARIATIONS. CONTACT THE DESIGNER AT A&M ASSOCIATES TO FIND A SOLUTION. P: 602.623.6841

D2 - THE PROPOSED PROJECT CONSISTS OF **42" WIDE IMP**. DEVIATING FROM THIS SIZE PANEL WILL ALTER THE LYRICAL FIN DESIGN. PLEASE CONTACT THE DESIGNER AT A&M ASSOCIATES SO THE PLAN DRAWINGS CAN BE UPDATED. P: 602.623.6841


COLORS			
A	GALVALUME	F	TERRA COTTA
B	SW 6767 AQUARIUM	G	MIXED LIGHT STONE
C	IMPERIAL WHITE		
D	SANDSTONE		
E	WALNUT		

MATERIALS			
1	KINGSPAN DESIGN WALL 2000 STUCCO TEXTURE	6	12"H CORNICE TRIM
2	SCUPPERS	7	NUCOR ROOF PANELING
3	WOOD TEXTURED LAP PANELS W/ 2" GALVANIZED TRIM (installed over IMP)	8	LOCALLY SOURCED STACKED STONE
4	TILT-UP CONCRETE LIGHT BROOM TEXTURE	9	SPANDREL WINDOWS
5	9"H x 3"D ARCHITECTURAL DETAILS	10	ARCHITECTURAL DETAILS

a&m
A&M ASSOCIATES, INC.
 2727 N. CENTRAL AVENUE
 PHOENIX, ARIZONA 85004
 P: 602.263.6841

U-HAUL
 of Murrieta
 Murrieta, CA
 (732035)

Colors & Materials
SHEET 03

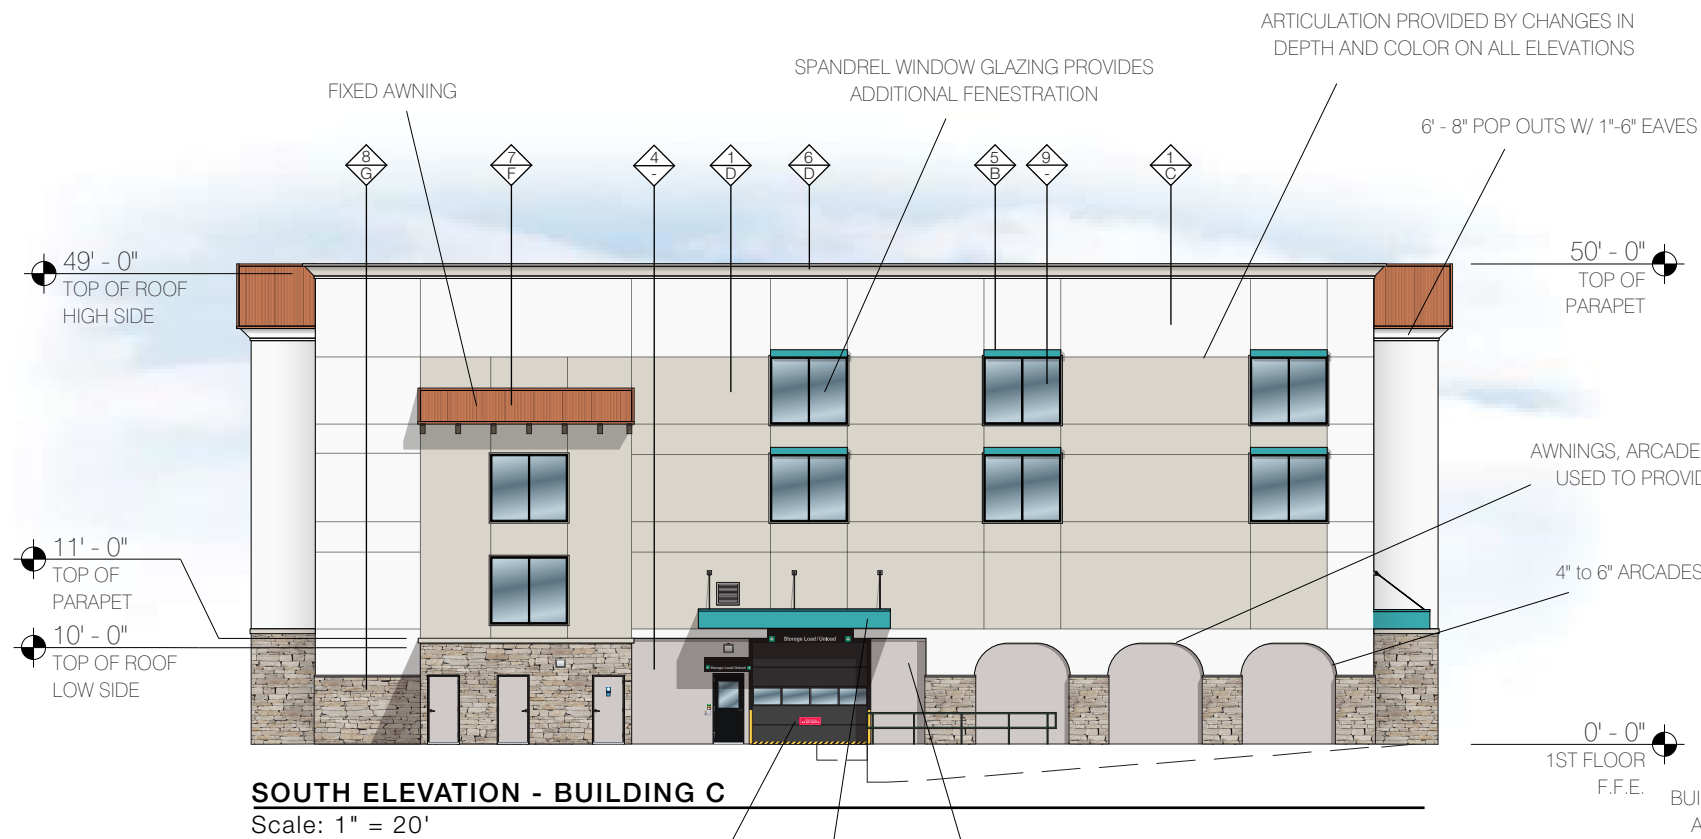

SOUTH ELEVATION - BUILDING C
Scale: 1" = 20'



WEST ELEVATION - BUILDING C
Scale: 1" = 20'

GENERAL NOTES:

D1 - THE PROPOSED IMP USES FULL-WIDTH PANELS. **DO NOT CUT IMP** DUE TO PAINT VARIATIONS. CONTACT THE DESIGNER AT A&M ASSOCIATES TO FIND A SOLUTION. P: 602.623.6841

D2 - THE PROPOSED PROJECT CONSISTS OF **42" WIDE IMP**. DEVIATING FROM THIS SIZE PANEL WILL ALTER THE LYRICAL FIN DESIGN. PLEASE CONTACT THE DESIGNER AT A&M ASSOCIATES SO THE PLAN DRAWINGS CAN BE UPDATED. P: 602.623.6841

COLORS

A	GALVALUME	F	TERRA COTTA
B	SW 6767 AQUARIUM	G	MIXED LIGHT STONE
C	IMPERIAL WHITE		
D	SANDSTONE		
E	WALNUT		

MATERIALS

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P: 602.263.6841



of Murrieta
Murrieta, CA
(732035)

Colors & Materials

SHEET 04

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Product Specifications **Designwall 2000**

Profile	Exterior: Flat Interior: Flat
Embossing	Exterior: Stucco, non-embossed or shadowline Interior: Stucco or non-embossed
Gauge	Exterior: 22, 20 ga Interior: 24, 22, 20 ga
Width	24" - 42"
Thickness	2", 2.5", 3", 4"
Length	2' - 24'
Reveal Options	1/8" - 6"
Orientation	Vertical or horizontal
Post Fabrication	Longitudinal bend, transverse bend, curve, trimless end, beveled edge, tapered edge, full end wrap (Manufacturing limitations apply. Please contact us for detailed information)
R-Value	≈ 7 per inch per ASTM C1363
Production method	Structurally bonded




Woodland Series

HORIZONTAL WOOD
WALNUT



**Stacked Stone
Light Stone**

LOCALLY SOURCED

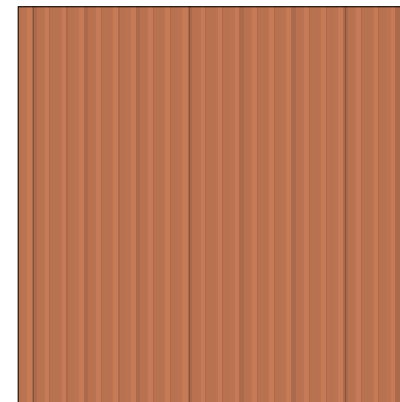

NUCOR Roof Paneling

TERRA COTTA



Tilt-Wall Concrete

LIGHT BROOM TEXTURE




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of Murrieta
Murrieta, CA
(732035)

Material Board

SHEET 05



SHEET NOTES:

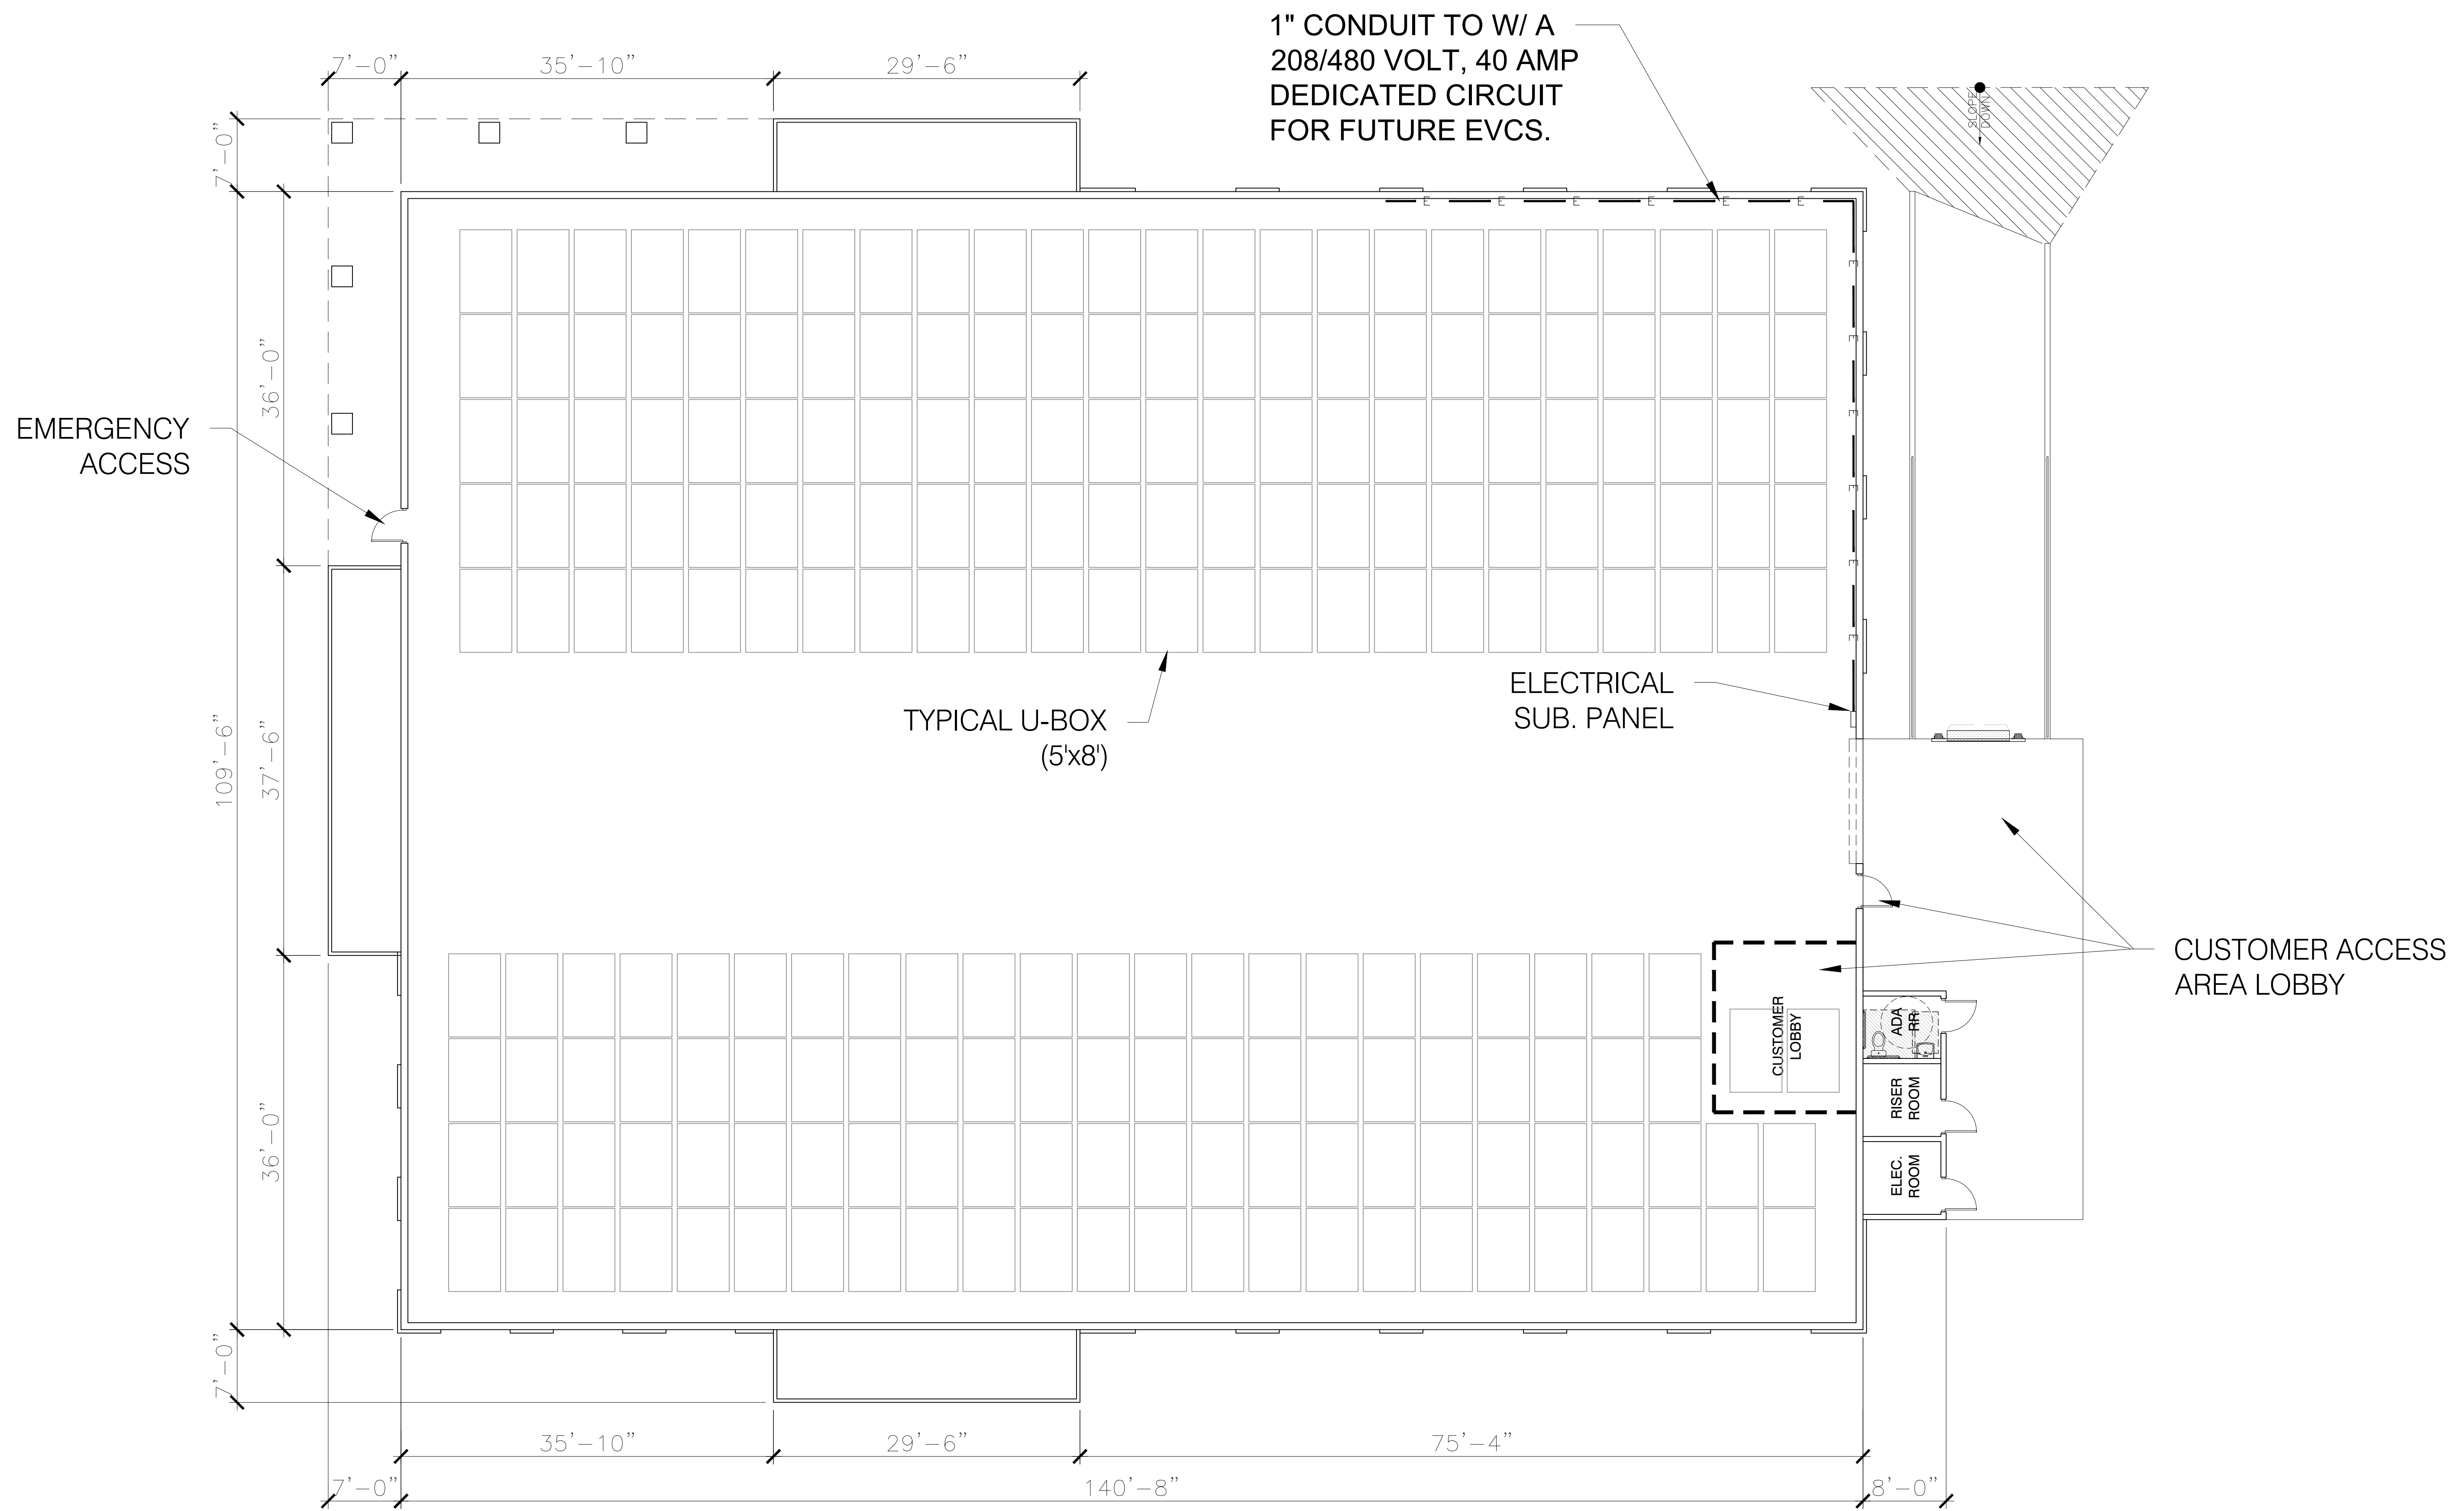NO.	DATE	INITIALS	NOTES
9	03/06/24	BLC	ADD POPOUTS PER ART IMAGING; DOOR REV'S
10	05/28/24	NH	SHOW INTERIOR LAYOUT PER CITY PLANNER

REVISIONS:

NO.	DATE	INITIALS	NOTES
1	10/12/21	JS	REV'D LANDSCAPE/SP2 PER CITY COMMENTS
2	02/17/22	JS	REV'D BUILDING "C" FLOOR PLAN
3	04/28/22	JS	REV'D SITE PLAN PER CITY COMMENTS
4	10/31/22	JS	REV'D FLOORPLAN TO MATCH ART DEPT
5	11/03/22	JS	UPDATED LAYOUT PER ELEVATIONS
6	02/14/23	JS	REV TO DOOR/COL. LOCATION
7	08/30/23	JS	REV PER COMM./ CUSTOMER AREA
8	10/20/23	NH	SITE REV'S

PROFESSIONAL SEAL:

**PRELIMINARY DOCUMENTS;
NOT FOR CONSTRUCTION;
FOR INFORMATION ONLY.**

ARCHITECT LOGO:

AMERCO
REAL ESTATE COMPANY

CONSTRUCTION DEPARTMENT
2727 NORTH CENTRAL AVENUE
PHOENIX, ARIZONA 85004
P: (602) 263-6502

SITE ADDRESS:
U-Haul of Murrieta
Murrieta, CA


SHEET CONTENTS:
PROPOSED BUILDING "C" FLOOR PLAN

732035

DRAWN:	JS
CHECKED:	NH
DATE:	02/16/2023

A2.1

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PROPOSED ROOF PLAN (CONCEPTUAL)

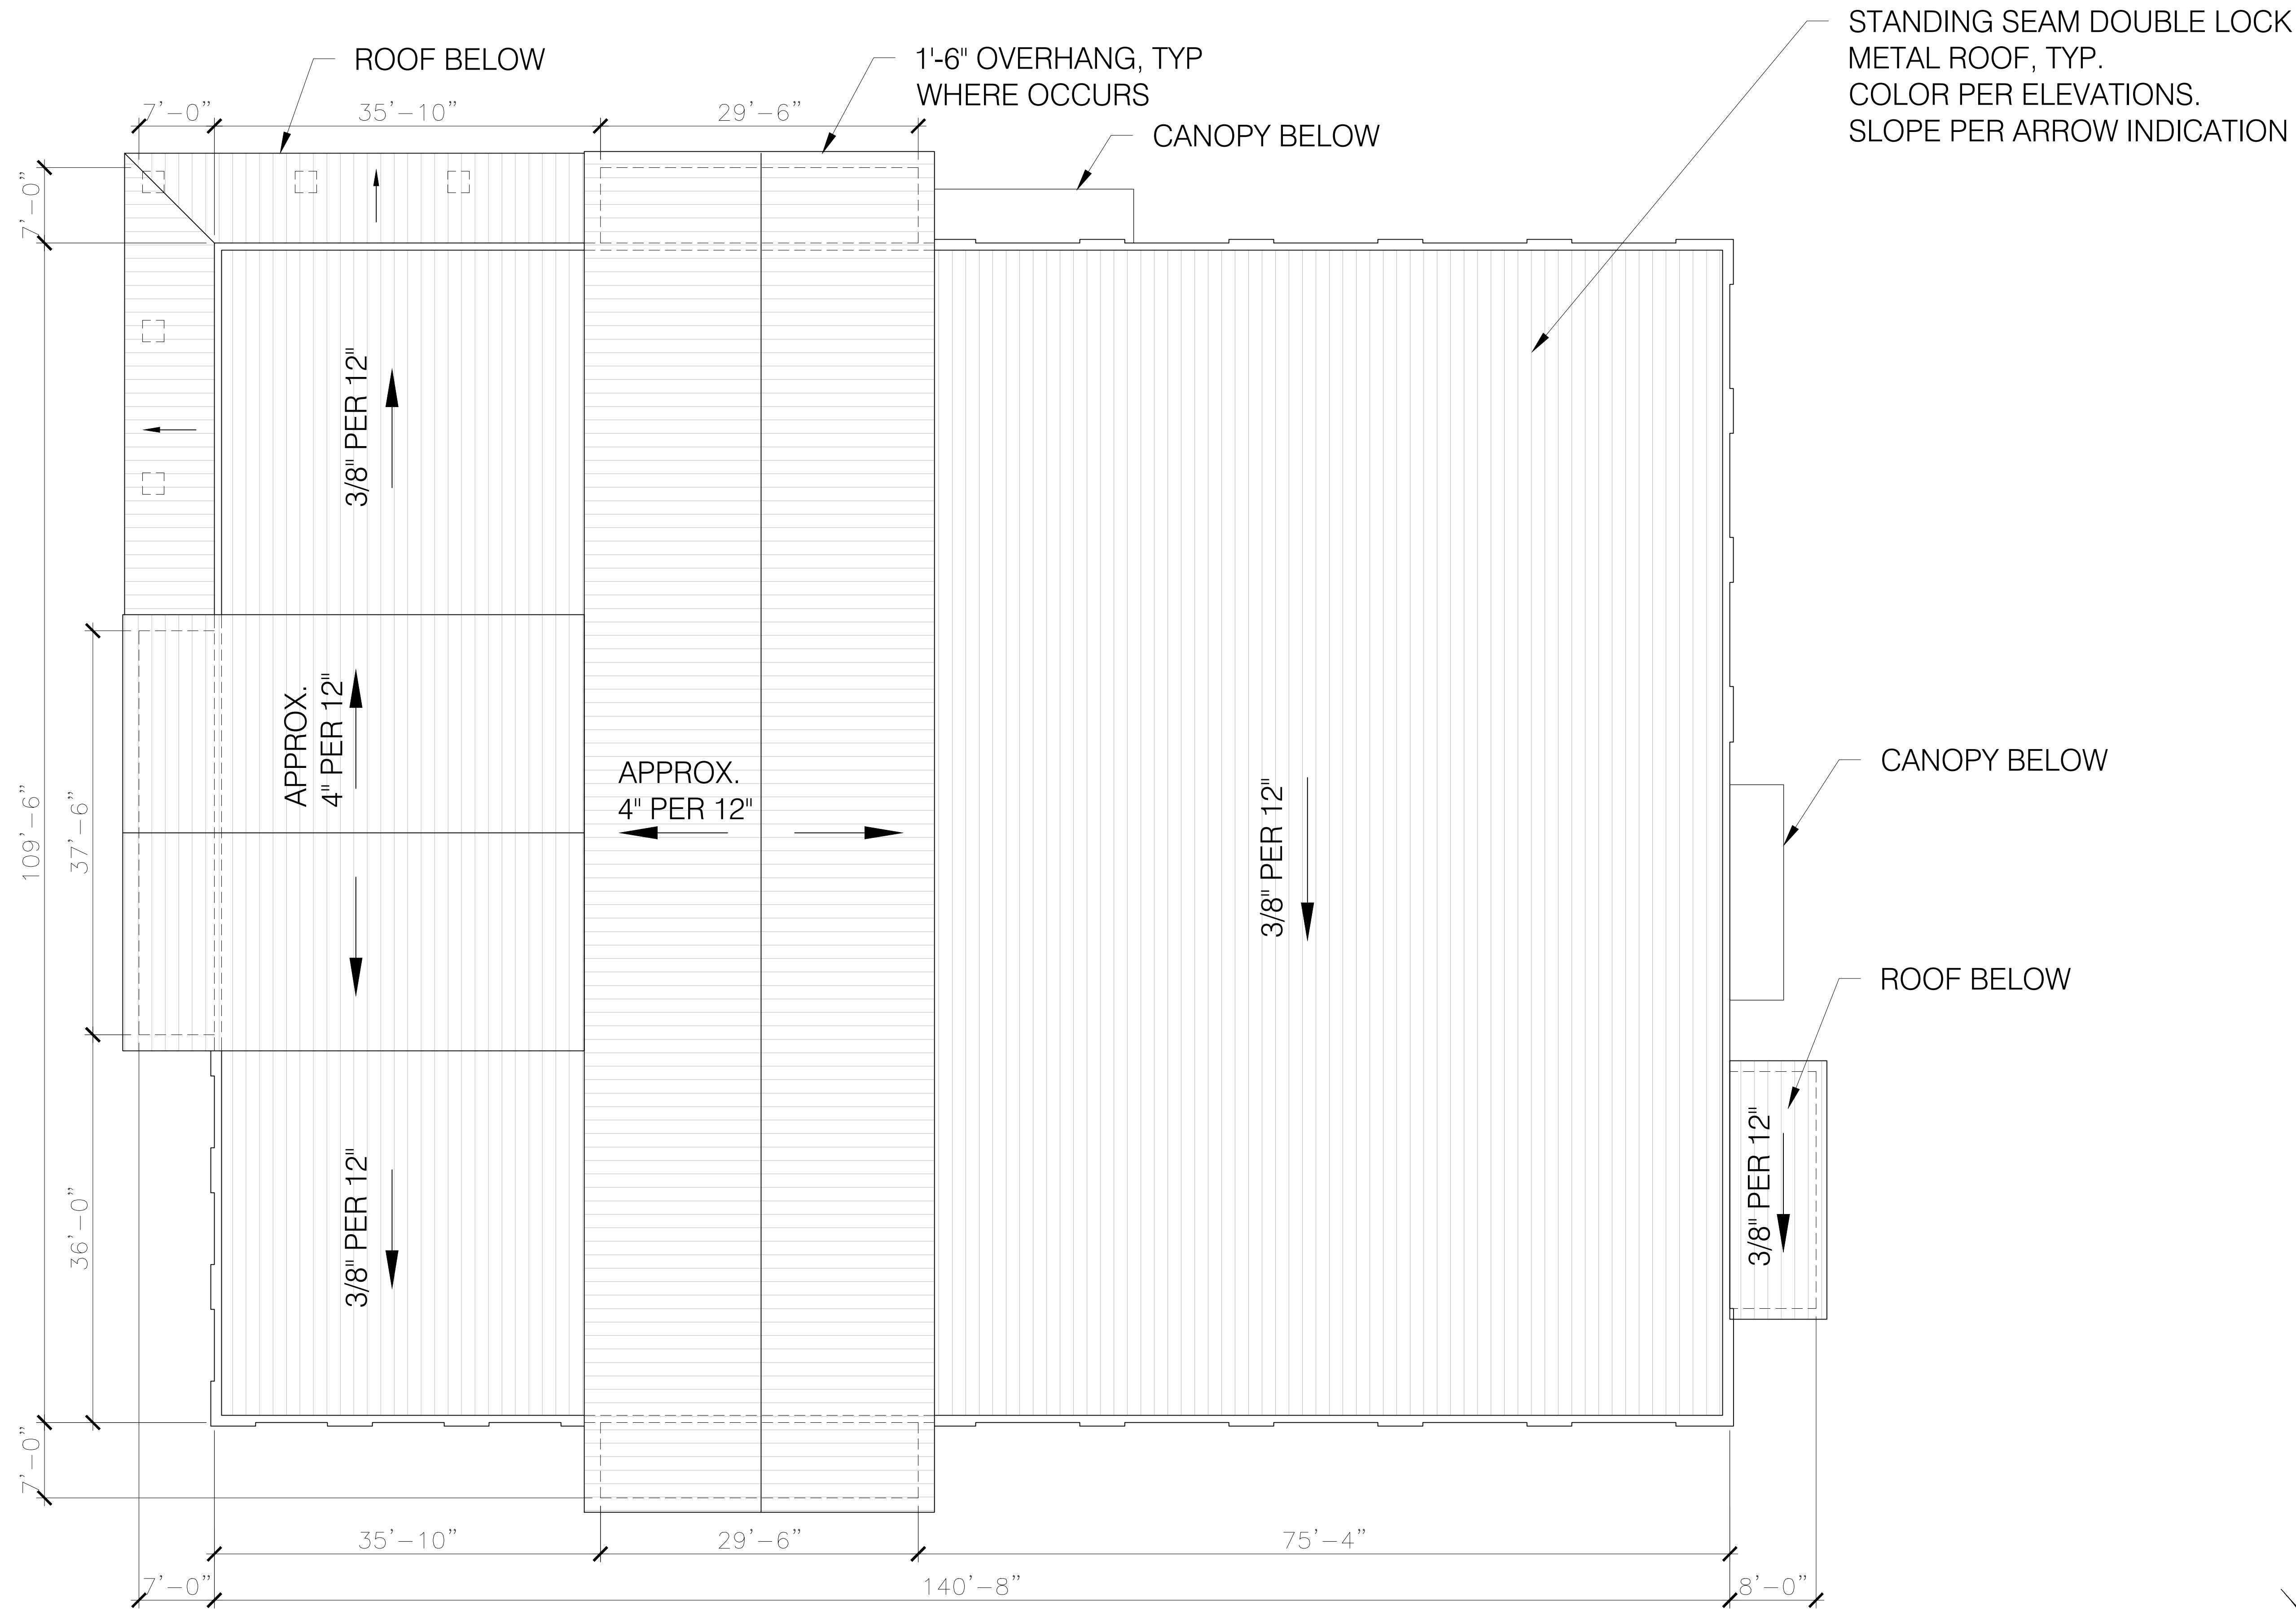SCALE: 1/8"=1'-0"

SHEET NOTES:

REVISIONS:

NO.	DATE	INITIALS	NOTES
1			
2			
3			
4			
5			
6			
7			
8			

PROFESSIONAL SEAL:

PRELIMINARY DOCUMENTS.
NOT FOR CONSTRUCTION.
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ARCHITECT LOGO:

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REAL ESTATE COMPANY

CONSTRUCTION DEPARTMENT
2727 NORTH CENTRAL AVENUE
PHOENIX, ARIZONA 85004
P: (602) 263-6502

SITE ADDRESS:
U-Haul of Murrieta
Murrieta, CA

SHEET CONTENTS:
PROPOSED
BUILDING "C"
CONCEPTUAL ROOF
PLAN

732035

DRAWN: NH
CHECKED: -
DATE: 05/16/24

A3.1

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Development Services
Department
Planning Division
Received on: 08/09/2024
Case #: